101 PARK AT NORTH HILLS STREET

FINAL SITE REVIEW & INFRASTRUCTURE CONSTRUCTION DRAWINGS

PUBLIC IMPROVEMENT QUANTITIES PHASE NUMBER: NUMBER OF LOTS: LOT NUMBERS BY PHASE: NUMBER OF UNITS: N/A OPEN SPACE: NUMBER OF OPEN SPACE LOTS: SEWER (PUBLIC) 0 LF 0 LF

SIDEWALK (PUBLIC

CASE NUMBER: XXXXXXX TRANSACTION NUMBER: XXXXXX RALEIGH, NORTH CAROLINA PROJECT NUMBER: DLR-14000

DATE: JUNE 30, 2015

DEVELOPER:

KANE CONCORD HOTEL EAST TWO, LLC 11410 COMMON OAKS DRIVE RALEIGH, NORTH CAROLINA 27614 **CONTACT: CARL HREN** PHONE: 919-455-2900 EMAIL: carl.hren@concordhotels.com

PARKING DATA PARKING REQUIRED 1 SPACE PER 250 SF 2,265/250 = 10 SPACES

135 ROOMS 1 SPACE PER ROOM 135 SPACES SUBTOTAL: 145 SPACES 10% LANDSCAPE PARKING REDUCTION 34% PDD REDUCTION ALLOWED TOTAL REQUIRED: 87 SPACES 13,070 SF IN TOWER 2 PARKING DECK AT THE ADJACENT NORTH HILLS 1 SPACE PER 250 SF EAST TOWER 2 SITE, THE 13,070/250 = 53 SPACES TOWER 2 DECK HAS 130 SURPLUS PARKING 284,197 SF IN TOWER 2

1 SPACE PER 300 SF 284,197/300 = 948 SPACESSUBTOTAL: 1,001 SPACES 10% LANDSCAPE PARKING REDUCTION 34% PDD REDUCTION ALLOWED TOTAL REQUIRED: 595 SPACES

PARKING IN DECK: 725 SPACES

Customer Service Center One Exchange Plaza 1 Exchange Plaza, Suite 40 Raleigh, North Carolina 2760 Phone 919-996-2495

Fax 919-516-2685

FINAL SITE AND COMMERCIAL BUILDING DATA SHEET | 08.07.13


Final Site and Commercial Building Data Sheet

Development Name Marriott at North Hills East					F	Proposed Use Hotel						
ro	perty Address(es) 1	01 F	Park at Nor	th H	Hills Stree	et						
V a	ke County Property I	dentifi	cation Number	(s) fo	or each parce	l to wh	nich these guidelines	s wil	appl	y		
P.I.N. 1706606148 P.I.N.					P.I.N.	I.N. P			P.I.N.	P.I.N.		
۷h	at is your project typ	e?			l							
	Apartment	Ва	ink		Elderly Facility	r	Hospital	Х	Hot	el/Motel		Industrial Building
	Mixed Residential		on-residential ondo		Office		Religious Institution		Res	sidential ndo	X	Retail
	School		opping		Single Family		Telecommunication Tower		Tow	vnhouse		Other

E ROWAN ST.	
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SIX FORMS RD.	Scope
DARTMOUTH	
	FOR
DAR TMOUTH RD.	FOR
/ / / / /	1. To
CURRITUCK DR. SITE	2. To
CURRITUCK DR. SITE	3. To
	DEVE
INTERSTATE	
1440	Zonin
	If mor
RAMBLEWOOD DR.	~0.5
N/AIII-	Overl
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COMPUTER DR.	ВОА
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COMPUTER DR.	Existi
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	. 100

VICINITY MAP

1'' = 1000'

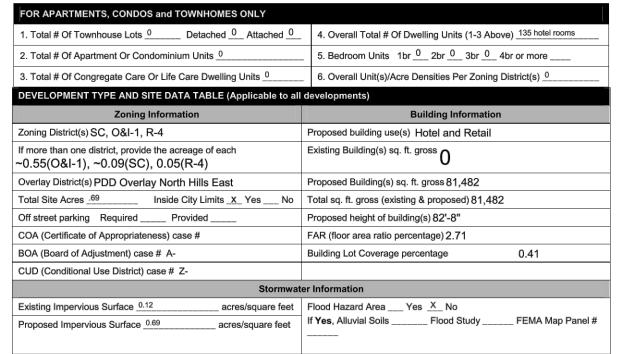

Neuse River Buffer ____ Yes X No Wetlands ____ Yes X No | Total Disturbed Area 0.7

SOLID WASTE COMPLIANCE STATEMENT:

- THE DEVELOPER ACKNOWLEDGES THAT THEY HAVE REVIEWED AND ARE IN COMPLIANCE WITH THE REQUIREMENTS SET FORTH
- 2. THE SOLID WASTE REMOVAL FOR THIS PROJECT WILL BE HANDLED BY A PRIVATE SERVICE.
- REFUSE WILL BE COLLECTED IN A CENTRAL COLLECTION AND RECYCLING AREA WITHIN THE HOTEL. ACCESS TO THE REFUSE COLLECTION AREA IS OFF OF THE ALLEY BEHIND THE HOTEL.

ATTENTION CONTRACTORS

The Construction Contractor responsible for the extension of water, sewer, and/or reuse, as approved in these plans, is responsible for contacting the Public Works Department at (919) 996-2409, and the **Public Utilities Department** at (919) 996-4540 at least twenty four hours prior to beginning any of their construction.

Failure to notify both City Departments in advance of beginning construction, will result in the issuance of monetary fines, and require reinstallation of any water or sewer facilities not inspected as a result of this notification failure.

Failure to call for Inspection, Install a Downstream Plug, have Permitted Plans on the Jobsite, or any other Violation of City of Raleigh Standards will result in a Fine and Possible Exclusion from future work in the City of Raleigh.

CITY OF RALEIGH All Construction must be in accordance with all Local, State, and Federal Rules and Regulations TRANSPORTATION SERVICES PUBLIC UTILITIES STORMWATER URBAN FORESTRY

SHEET INDEX

- **DEMOLITION PLAN** SITE PLAN
- GRADING AND STORM DRAINAGE PLAN
- **UTILITY PLAN**
- **EROSION CONTROL PLAN STAGE 1 EROSION CONTROL PLAN - STAGE 2**
- NPDES PLAN
- **EROSION CONTROL DETAILS**
- LANDSCAPE PLAN SITE DETAILS
- **UTILITY AND STORM DRAINAGE DETAILS**
- UTILITY AND STORM DRAINAGE DETAILS
- **BUILDING ELEVATIONS BUILDING ELEVATIONS**
 - RECORDED PLAT


ALL CONSTRUCTION SHALL CONFORM WITH THE LATEST VERSION OF THE CITY OF RALEIGH STANDARDS AND SPECIFICATIONS.

NOTES

1. THE MINIMUM CORNER CLEARANCE FROM THE CURB LINE OR EDGE OF PAVEMENT INTERSECTING STREETS SHALL BE AT LEAST TWENTY (20) FEET FROM THE INTERSECTION OF THE RIGHT-OF-WAY LINES, WHICHEVER IS GREATER. THE RADIÚS OF THE DRIVEWAY SHALL NOT ENCROACH ON THE MINIMUM CORNER CLEARANCE.


2. WITHIN THE AREA OF A DEFINED SIGHT TRIANGLE, THERE SHALL BE NO SIGHT OBSTRUCTING OR PARTLY OBSTRUCTING WALL, FENCE, SIGN, FOLIAGE, BERMING OR PARKED VEHICLES BETWEEN THE HEIGHTS OF TWENTY-FOUR (24) INCHES AND EIGHT (8) FEET ABOVE THE CURB ELEVATION OR THE NEAREST TRAVELED WAY, IF NO CURBING EXISTS.



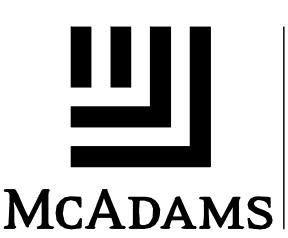

THE JOHN R. McADAMS COMPANY, INC.

2905 Meridian Parkway Durham, North Carolina 27713 License No.: C-0293 (800) 733-5646 • McAdamsCo.com Contact: Andy Padiak padiak@mcadamsco.com

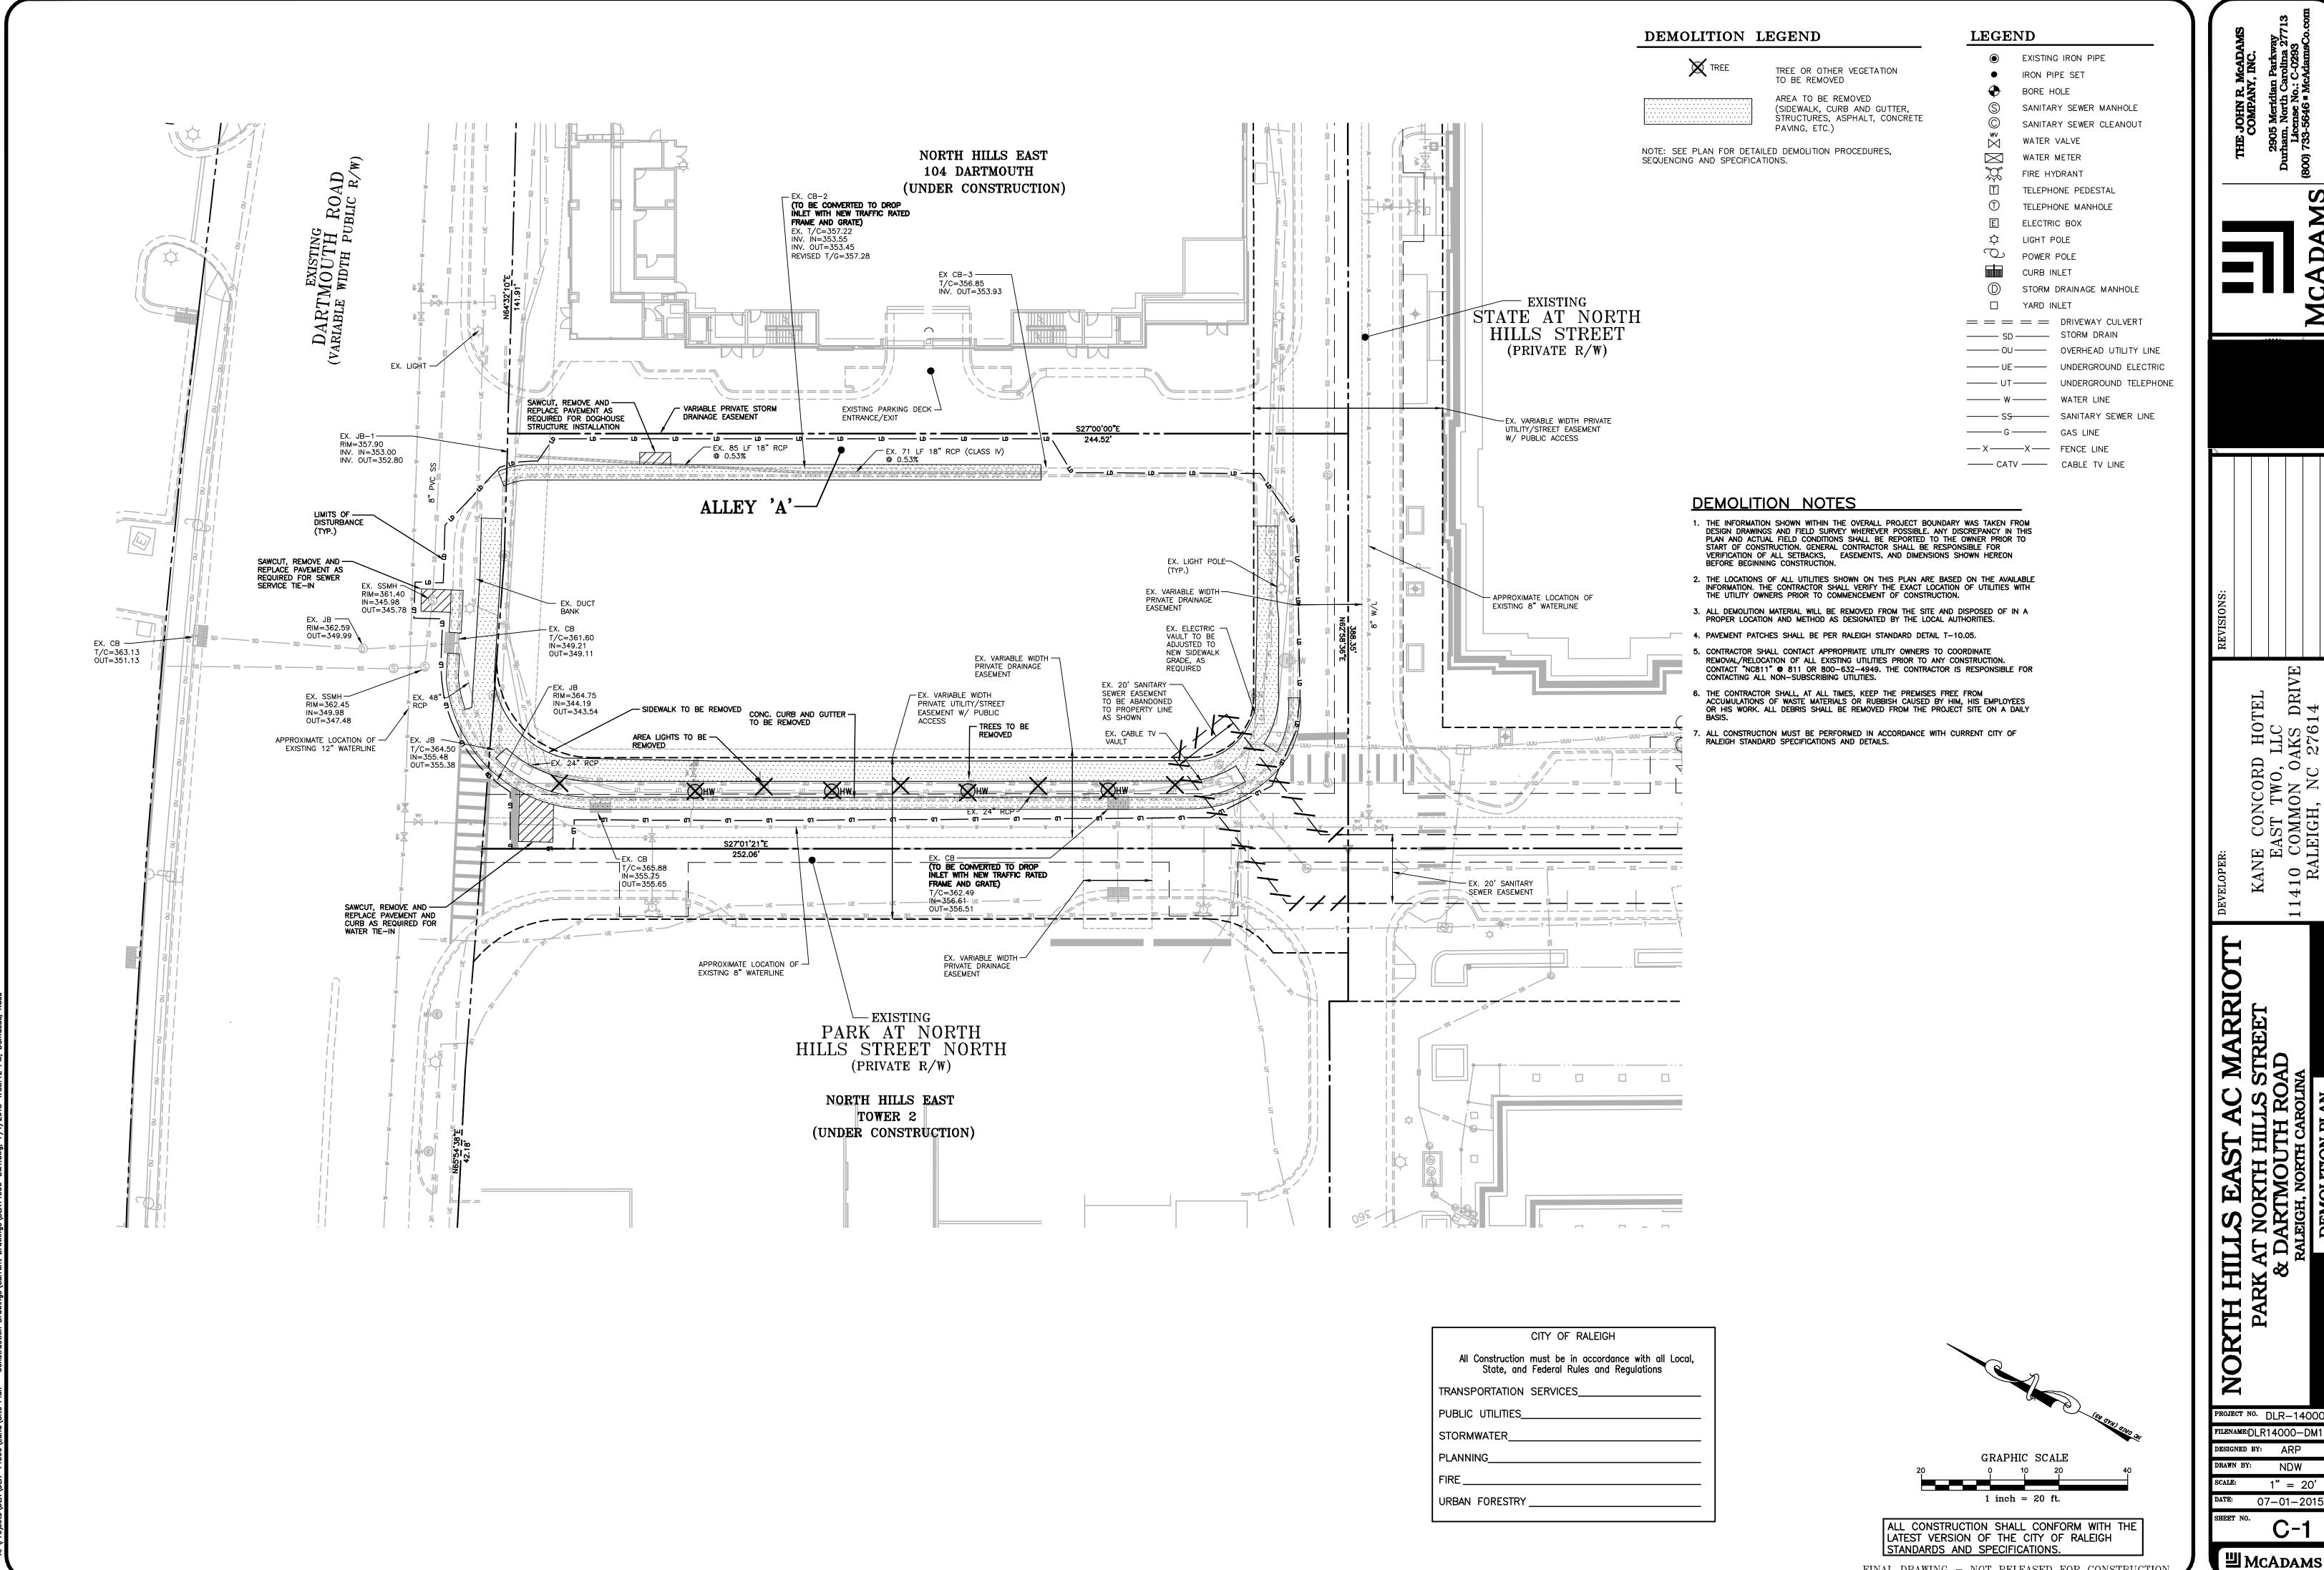


DRIV] WO, WO, NOA 410 RA

PROJECT NO. DLR-14000 FILENAME:DLR14000—DM1 DESIGNED BY: ARP NDW 1" = 20'


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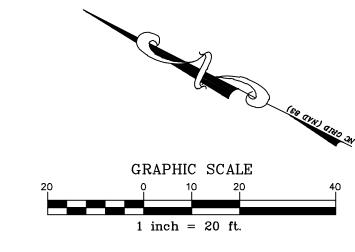
FINAL DRAWING - NOT RELEASED FOR CONSTRUCTION

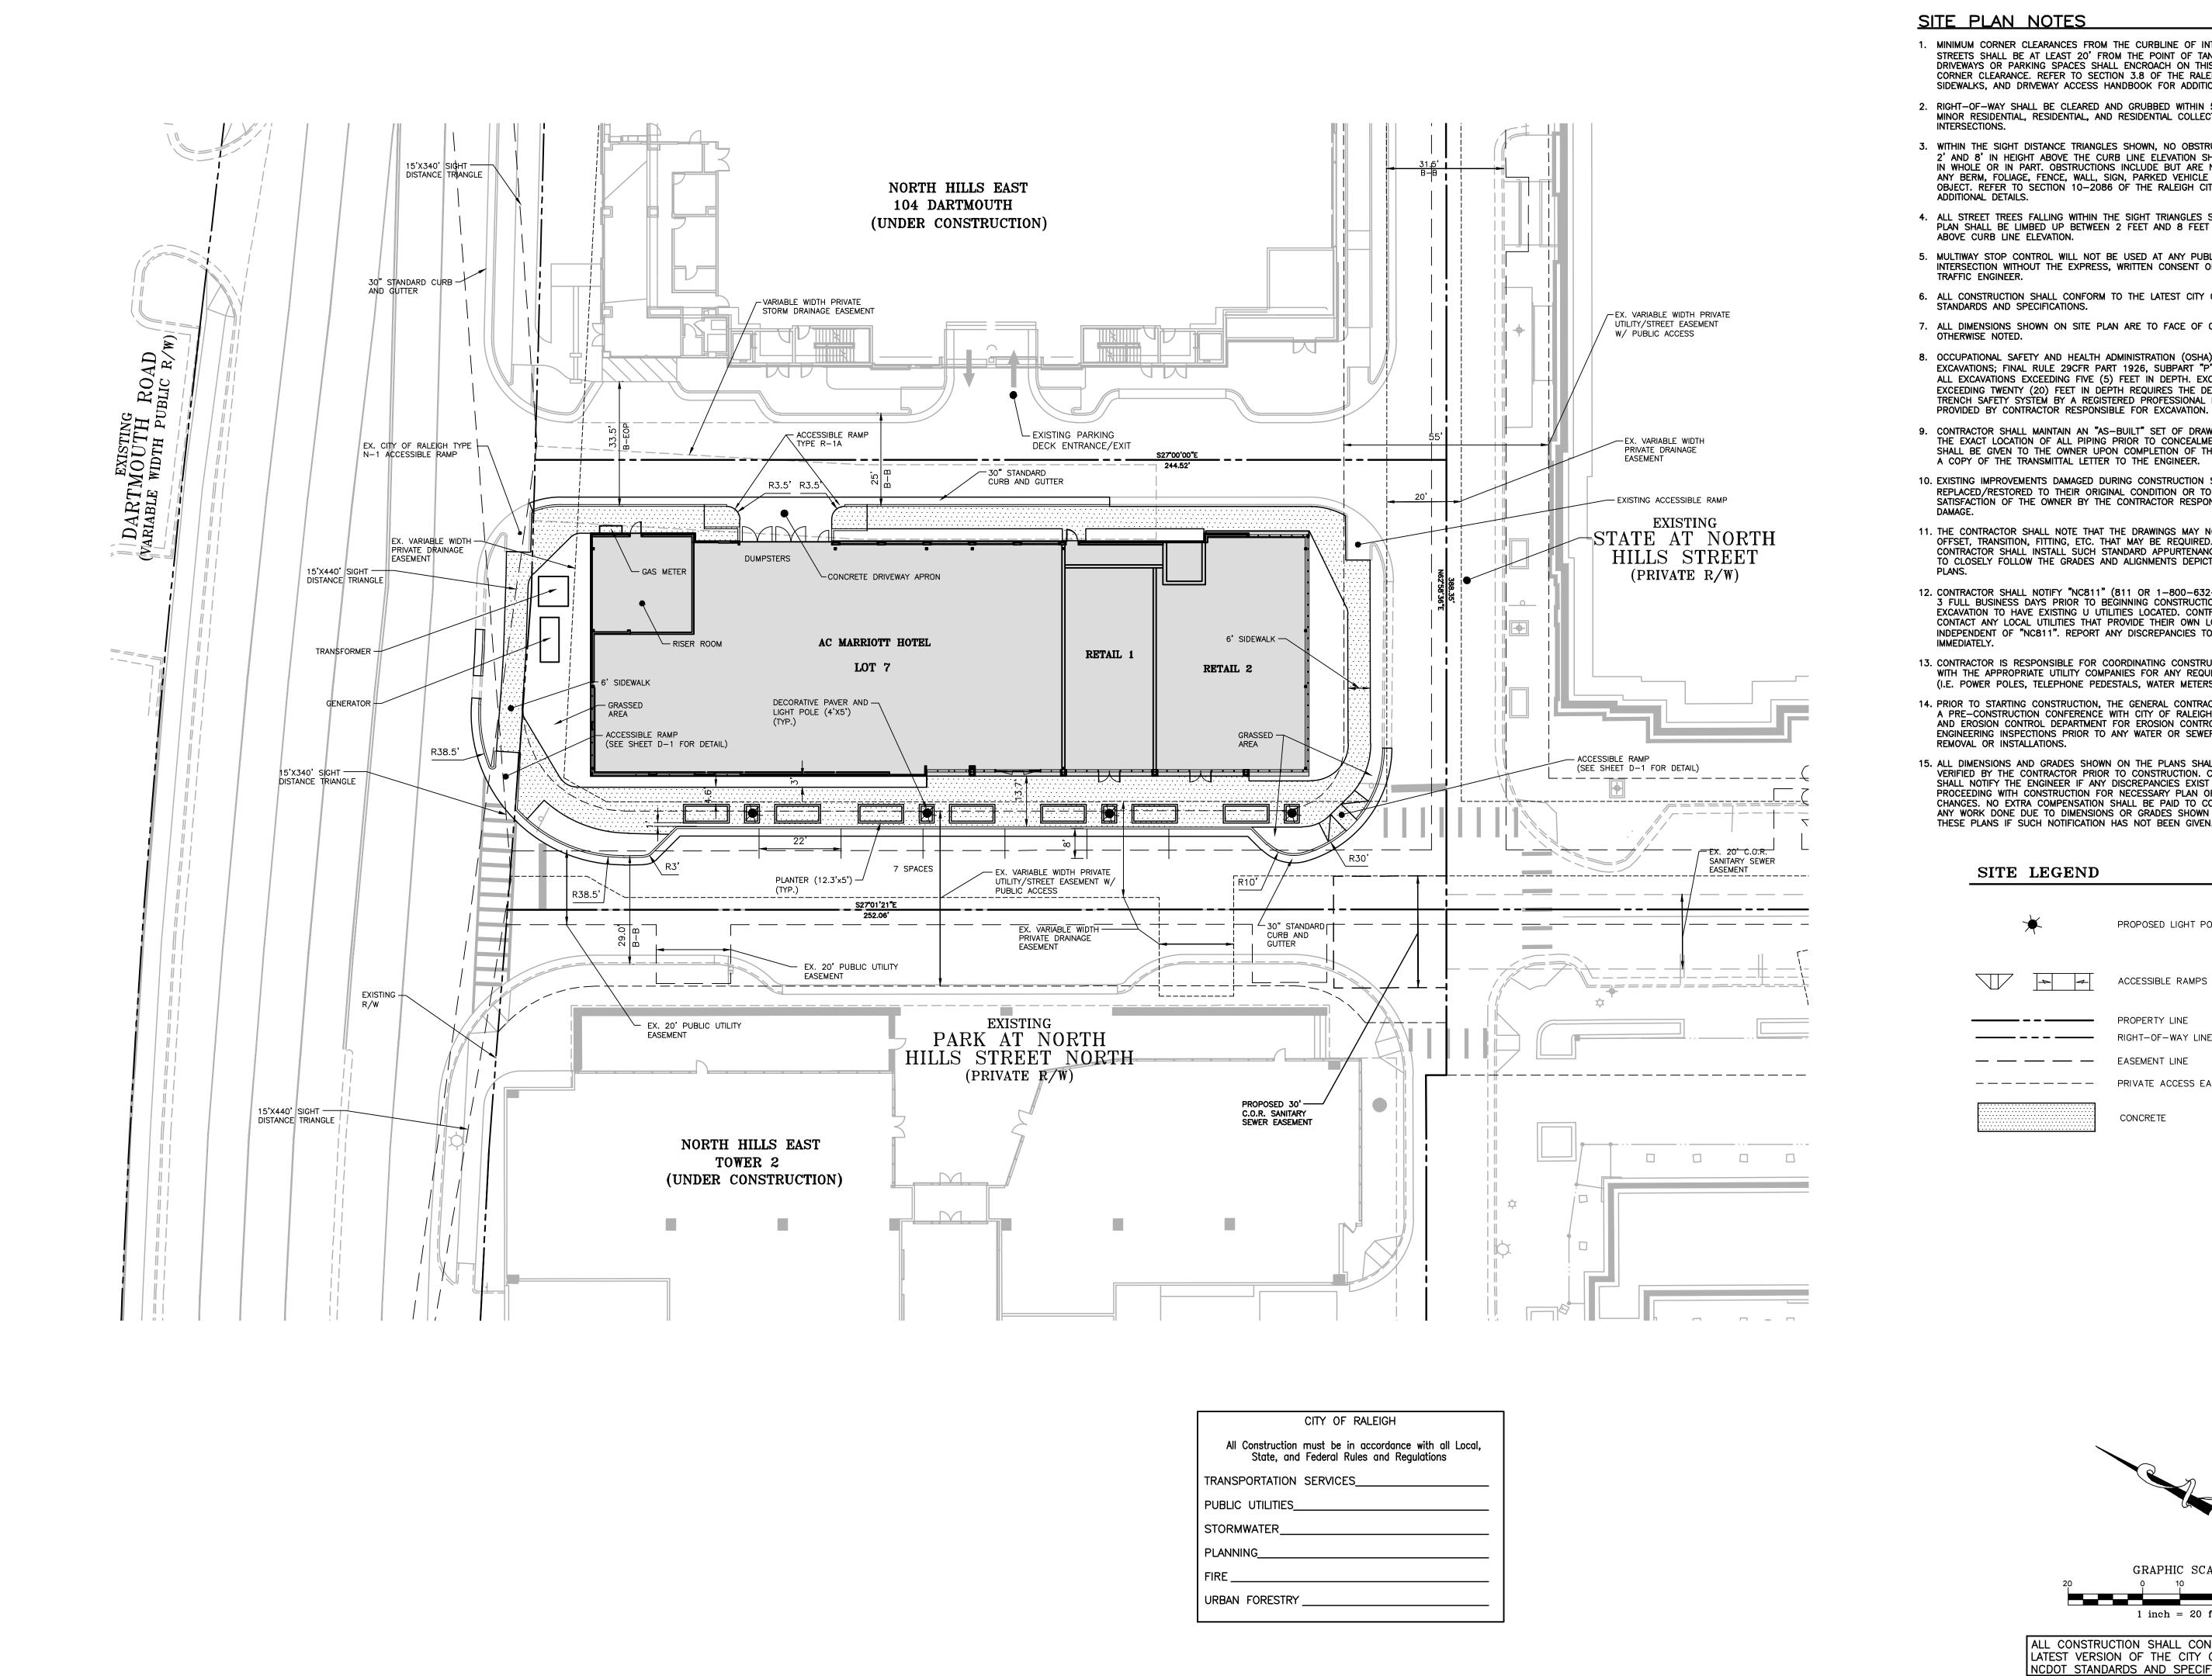

- 1. MINIMUM CORNER CLEARANCES FROM THE CURBLINE OF INTERSECTING STREETS SHALL BE AT LEAST 20' FROM THE POINT OF TANGENCY. NO DRIVEWAYS OR PARKING SPACES SHALL ENCROACH ON THIS MINIMUM CORNER CLEARANCE. REFER TO SECTION 3.8 OF THE RALEIGH STREETS. SIDEWALKS, AND DRIVEWAY ACCESS HANDBOOK FOR ADDITIONAL DETAILS.
- 2. RIGHT-OF-WAY SHALL BE CLEARED AND GRUBBED WITHIN 50' OF ALL MINOR RESIDENTIAL, RESIDENTIAL, AND RESIDENTIAL COLLECTOR
- 3. WITHIN THE SIGHT DISTANCE TRIANGLES SHOWN, NO OBSTRUCTION BETWEEN 2' AND 8' IN HEIGHT ABOVE THE CURB LINE ELEVATION SHALL BE LOCATED IN WHOLE OR IN PART. OBSTRUCTIONS INCLUDE BUT ARE NOT LIMITED TO ANY BERM, FOLIAGE, FENCE, WALL, SIGN, PARKED VEHICLE OR OTHER OBJECT. REFER TO SECTION 10-2086 OF THE RALEIGH CITY CODE FOR
- 4. ALL STREET TREES FALLING WITHIN THE SIGHT TRIANGLES SHOWN ON THIS PLAN SHALL BE LIMBED UP BETWEEN 2 FEET AND 8 FEET IN HEIGHT
- 5. MULTIWAY STOP CONTROL WILL NOT BE USED AT ANY PUBLIC STREET INTERSECTION WITHOUT THE EXPRESS, WRITTEN CONSENT OF THE CITY
- 6. ALL CONSTRUCTION SHALL CONFORM TO THE LATEST CITY OF RALEIGH
- 7. ALL DIMENSIONS SHOWN ON SITE PLAN ARE TO FACE OF CURB UNLESS
- 8. OCCUPATIONAL SAFETY AND HEALTH ADMINISTRATION (OSHA) STANDARDS FOR EXCAVATIONS; FINAL RULE 29CFR PART 1926, SUBPART "P" APPLIES TO ALL EXCAVATIONS EXCEEDING FIVE (5) FEET IN DEPTH. EXCAVATION EXCEEDING TWENTY (20) FEET IN DEPTH REQUIRES THE DESIGN OF A TRENCH SAFETY SYSTEM BY A REGISTERED PROFESSIONAL ENGINEER,
- 9. CONTRACTOR SHALL MAINTAIN AN "AS-BUILT" SET OF DRAWINGS TO RECORD THE EXACT LOCATION OF ALL PIPING PRIOR TO CONCEALMENT. DRAWINGS SHALL BE GIVEN TO THE OWNER UPON COMPLETION OF THE PROJECT WITH A COPY OF THE TRANSMITTAL LETTER TO THE ENGINEER.
- 10. EXISTING IMPROVEMENTS DAMAGED DURING CONSTRUCTION SHALL BE REPLACED/RESTORED TO THEIR ORIGINAL CONDITION OR TO THE SATISFACTION OF THE OWNER BY THE CONTRACTOR RESPONSIBLE FOR THE
- 11. THE CONTRACTOR SHALL NOTE THAT THE DRAWINGS MAY NOT SHOW EVERY OFFSET, TRANSITION, FITTING, ETC. THAT MAY BE REQUIRED. THE CONTRACTOR SHALL INSTALL SUCH STANDARD APPURTENANCES AS REQUIRED TO CLOSELY FOLLOW THE GRADES AND ALIGNMENTS DEPICTED ON THE
- 12. CONTRACTOR SHALL NOTIFY "NC811" (811 OR 1-800-632-4949) AT LEAST 3 FULL BUSINESS DAYS PRIOR TO BEGINNING CONSTRUCTION OR EXCAVATION TO HAVE EXISTING U UTILITIES LOCATED. CONTRACTOR TO CONTACT ANY LOCAL UTILITIES THAT PROVIDE THEIR OWN LOCATOR SERVICES INDEPENDENT OF "NC811". REPORT ANY DISCREPANCIES TO THE ENGINEER
- 13. CONTRACTOR IS RESPONSIBLE FOR COORDINATING CONSTRUCTION ACTIVITIES WITH THE APPROPRIATE UTILITY COMPANIES FOR ANY REQUIRED RELOCATION (I.E. POWER POLES, TELEPHONE PEDESTALS, WATER METERS, ETC.).
- 14. PRIOR TO STARTING CONSTRUCTION, THE GENERAL CONTRACTOR SHALL HOLD A PRE-CONSTRUCTION CONFERENCE WITH CITY OF RALEIGH STORMWATER AND EROSION CONTROL DEPARTMENT FOR EROSION CONTROL AND ENGINEERING INSPECTIONS PRIOR TO ANY WATER OR SEWER ABANDONMENT,
- 15. ALL DIMENSIONS AND GRADES SHOWN ON THE PLANS SHALL BE FIELD VERIFIED BY THE CONTRACTOR PRIOR TO CONSTRUCTION. CONTRACTOR SHALL NOTIFY THE ENGINEER IF ANY DISCREPANCIES EXIST PRIOR TO PROCEEDING WITH CONSTRUCTION FOR NECESSARY PLAN OR GRADE CHANGES. NO EXTRA COMPENSATION SHALL BE PAID TO CONTRACTOR FOR ANY WORK DONE DUE TO DIMENSIONS OR GRADES SHOWN INCORRECTLY ON THESE PLANS IF SUCH NOTIFICATION HAS NOT BEEN GIVEN.

SITE LEGEND



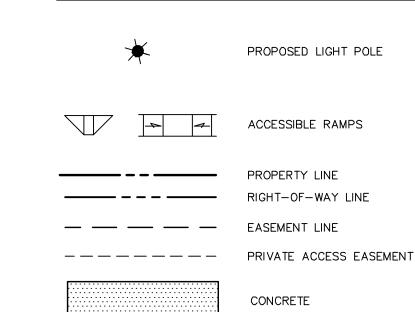

ALL CONSTRUCTION SHALL CONFORM WITH THE LATEST VERSION OF THE CITY OF RALEIGH AND NCDOT STANDARDS AND SPECIFICATIONS.

FINAL DRAWING - NOT RELEASED FOR CONSTRUCTION

DRIV. OA C WO, WO, NOA T TW IMON

410RAJ $\overline{}$ MARRIOTT STREET


HILL

NORTH PROJECT NO. DLR-14000 FILENAME:DLR14000—S1

DESIGNED BY: ARP NDW 1" = 20'07-01-2015

C-2

MCADAMS

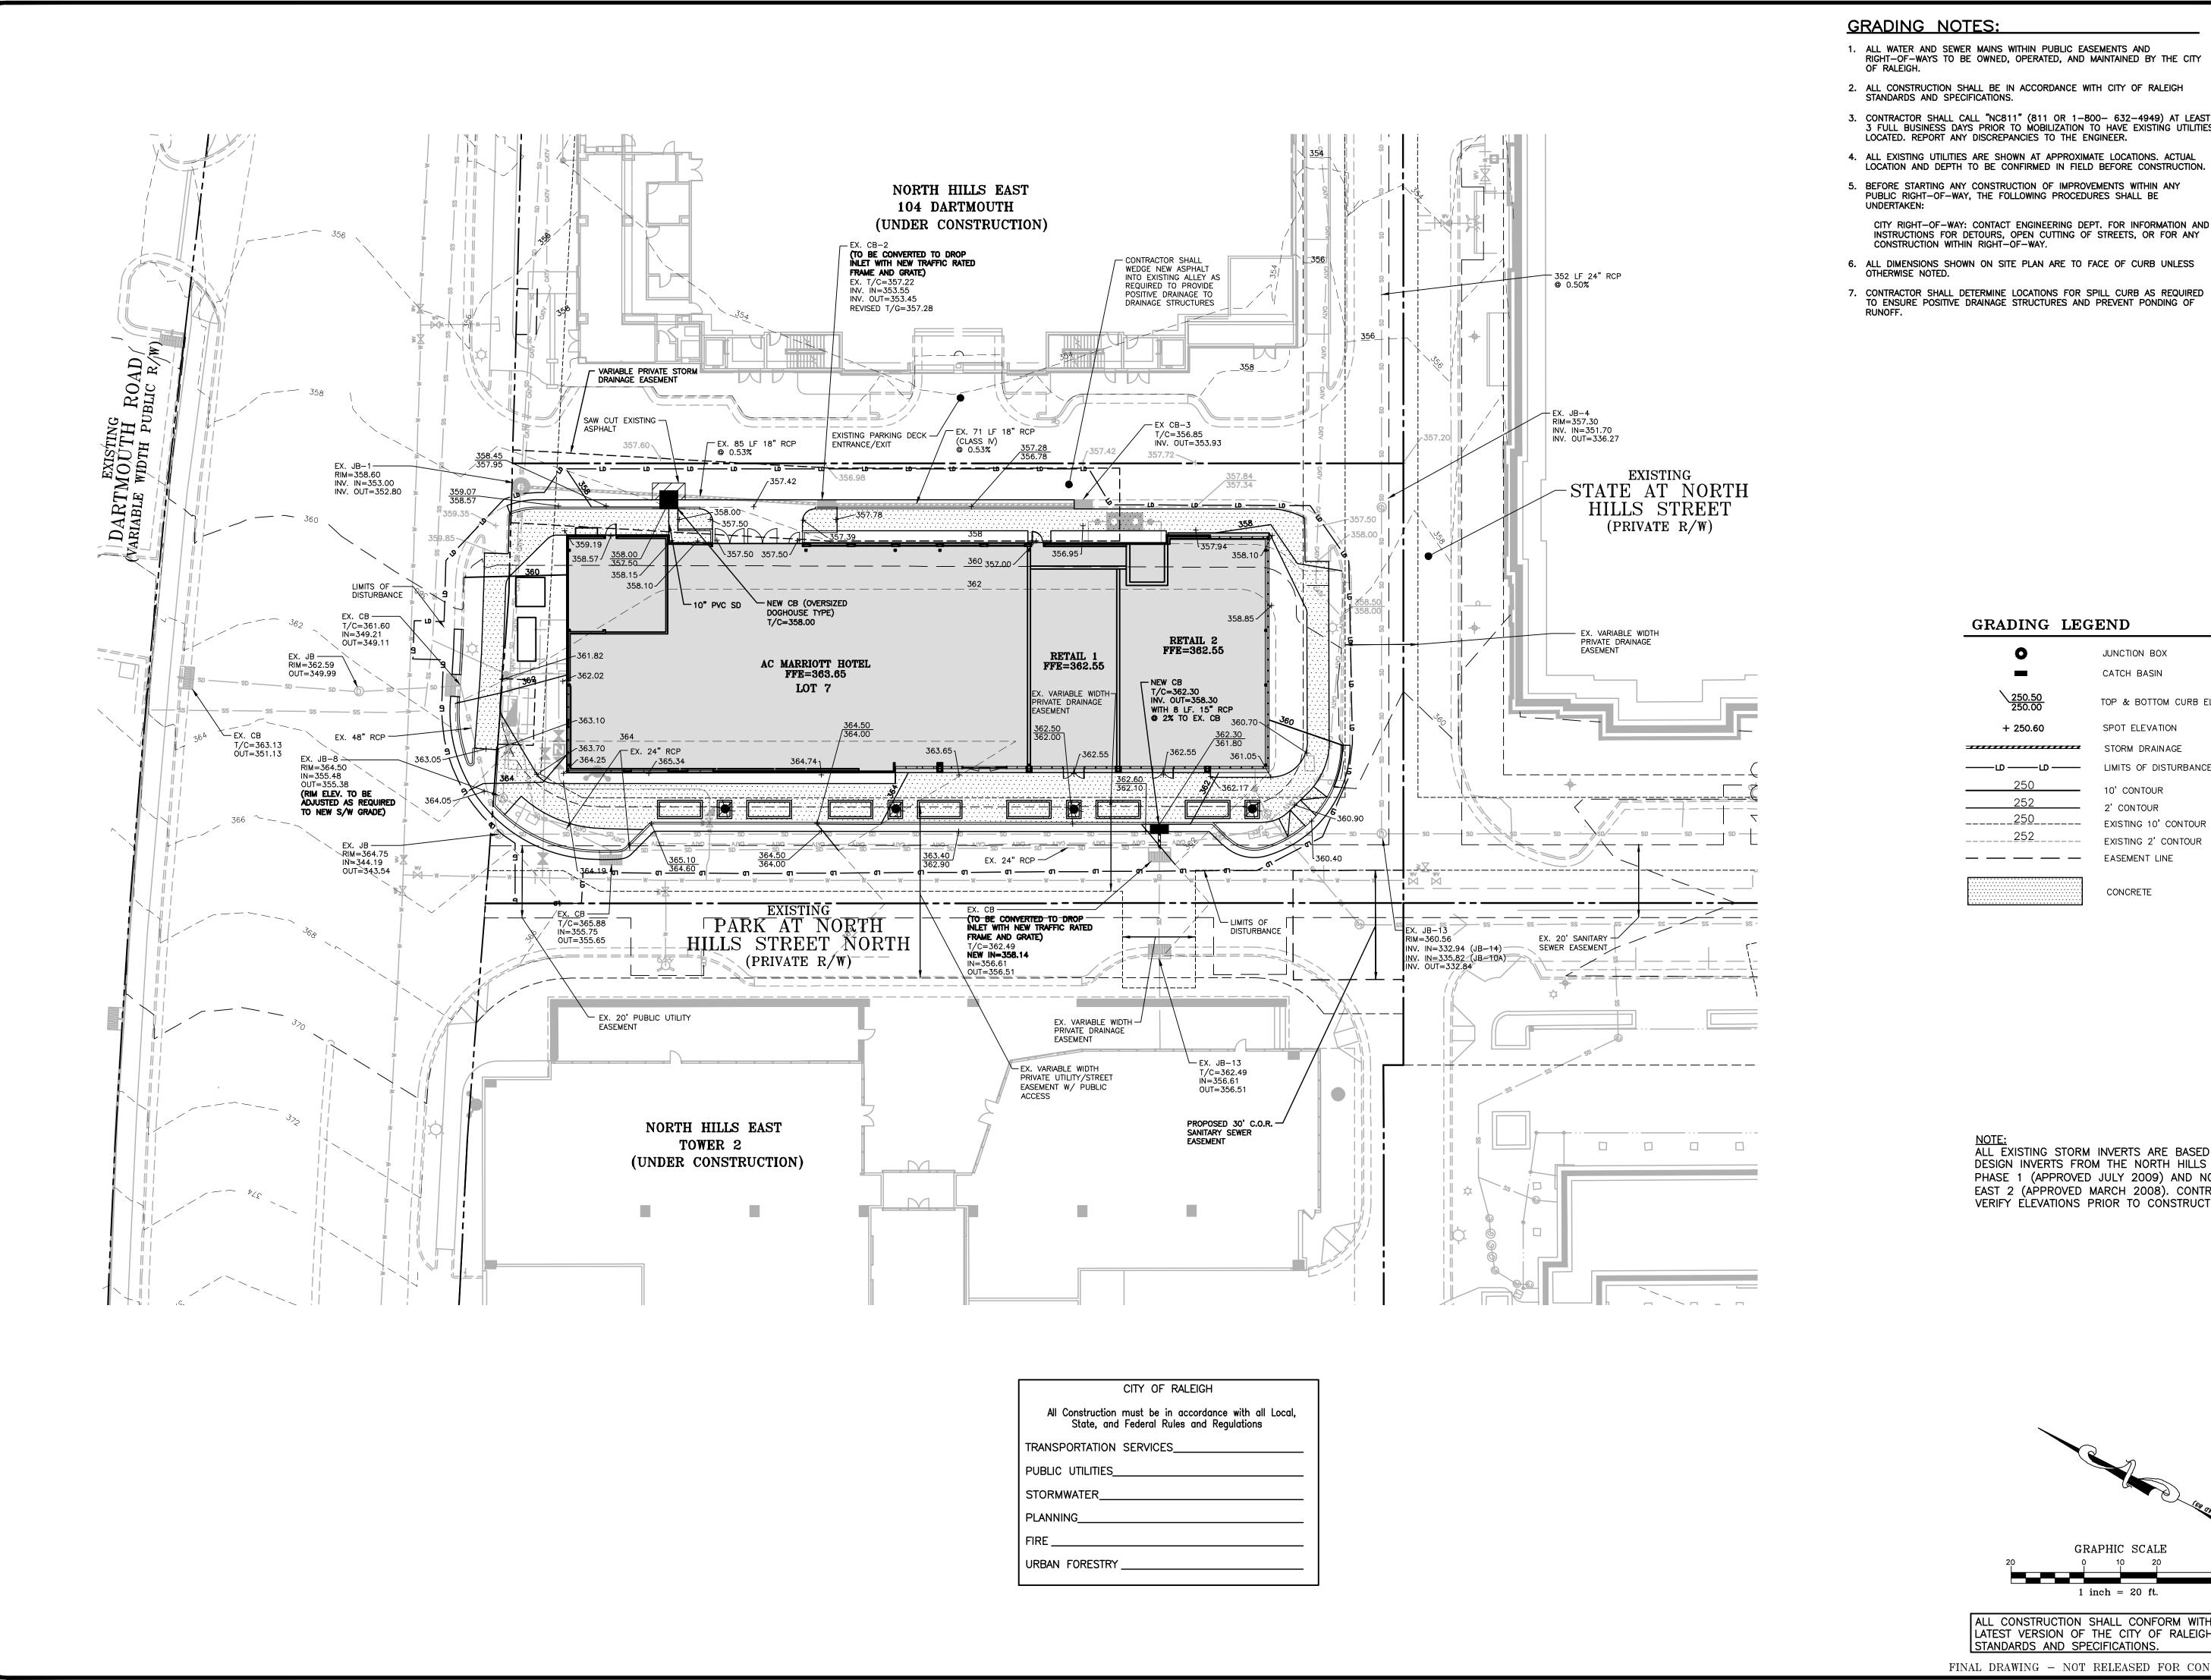

1. ALL WATER AND SEWER MAINS WITHIN PUBLIC EASEMENTS AND RIGHT-OF-WAYS TO BE OWNED, OPERATED, AND MAINTAINED BY THE CITY

CONTRACTOR SHALL CALL "NC811" (811 OR 1-800- 632-4949) AT LEAST
 3 FULL BUSINESS DAYS PRIOR TO MOBILIZATION TO HAVE EXISTING UTILITIES
 LOCATED. REPORT ANY DISCREPANCIES TO THE ENGINEER.

4. ALL EXISTING UTILITIES ARE SHOWN AT APPROXIMATE LOCATIONS. ACTUAL LOCATION AND DEPTH TO BE CONFIRMED IN FIELD BEFORE CONSTRUCTION.


5. BEFORE STARTING ANY CONSTRUCTION OF IMPROVEMENTS WITHIN ANY PUBLIC RIGHT-OF-WAY, THE FOLLOWING PROCEDURES SHALL BE

CITY RIGHT-OF-WAY: CONTACT ENGINEERING DEPT. FOR INFORMATION AND INSTRUCTIONS FOR DETOURS, OPEN CUTTING OF STREETS, OR FOR ANY CONSTRUCTION WITHIN RIGHT-OF-WAY.

6. ALL DIMENSIONS SHOWN ON SITE PLAN ARE TO FACE OF CURB UNLESS

JUNCTION BOX CATCH BASIN TOP & BOTTOM CURB ELEVATIONS SPOT ELEVATION STORM DRAINAGE LIMITS OF DISTURBANCE 10' CONTOUR 2' CONTOUR _____250_____ EXISTING 10' CONTOUR EXISTING 2' CONTOUR — — — EASEMENT LINE

NOTE: ALL EXISTING STORM INVERTS ARE BASED ON DESIGN INVERTS FROM THE NORTH HILLS EAST PHASE 1 (APPROVED JULY 2009) AND NORTH HILL EAST 2 (APPROVED MARCH 2008). CONTRACTOR TO VERIFY ELEVATIONS PRIOR TO CONSTRUCTION.

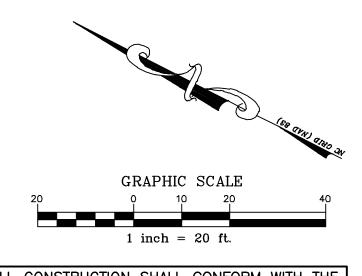

ALL CONSTRUCTION SHALL CONFORM WITH THE LATEST VERSION OF THE CITY OF RALEIGH

FINAL DRAWING - NOT RELEASED FOR CONSTRUCTION


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KANE CC EAST 410 COM RALEIG

MARRIOTT STREET DAD

HILL

PROJECT NO. DLR-14000 FILENAME:DLR14000—G1 DESIGNED BY: ARP NDW 1" = 20'07-01-2015

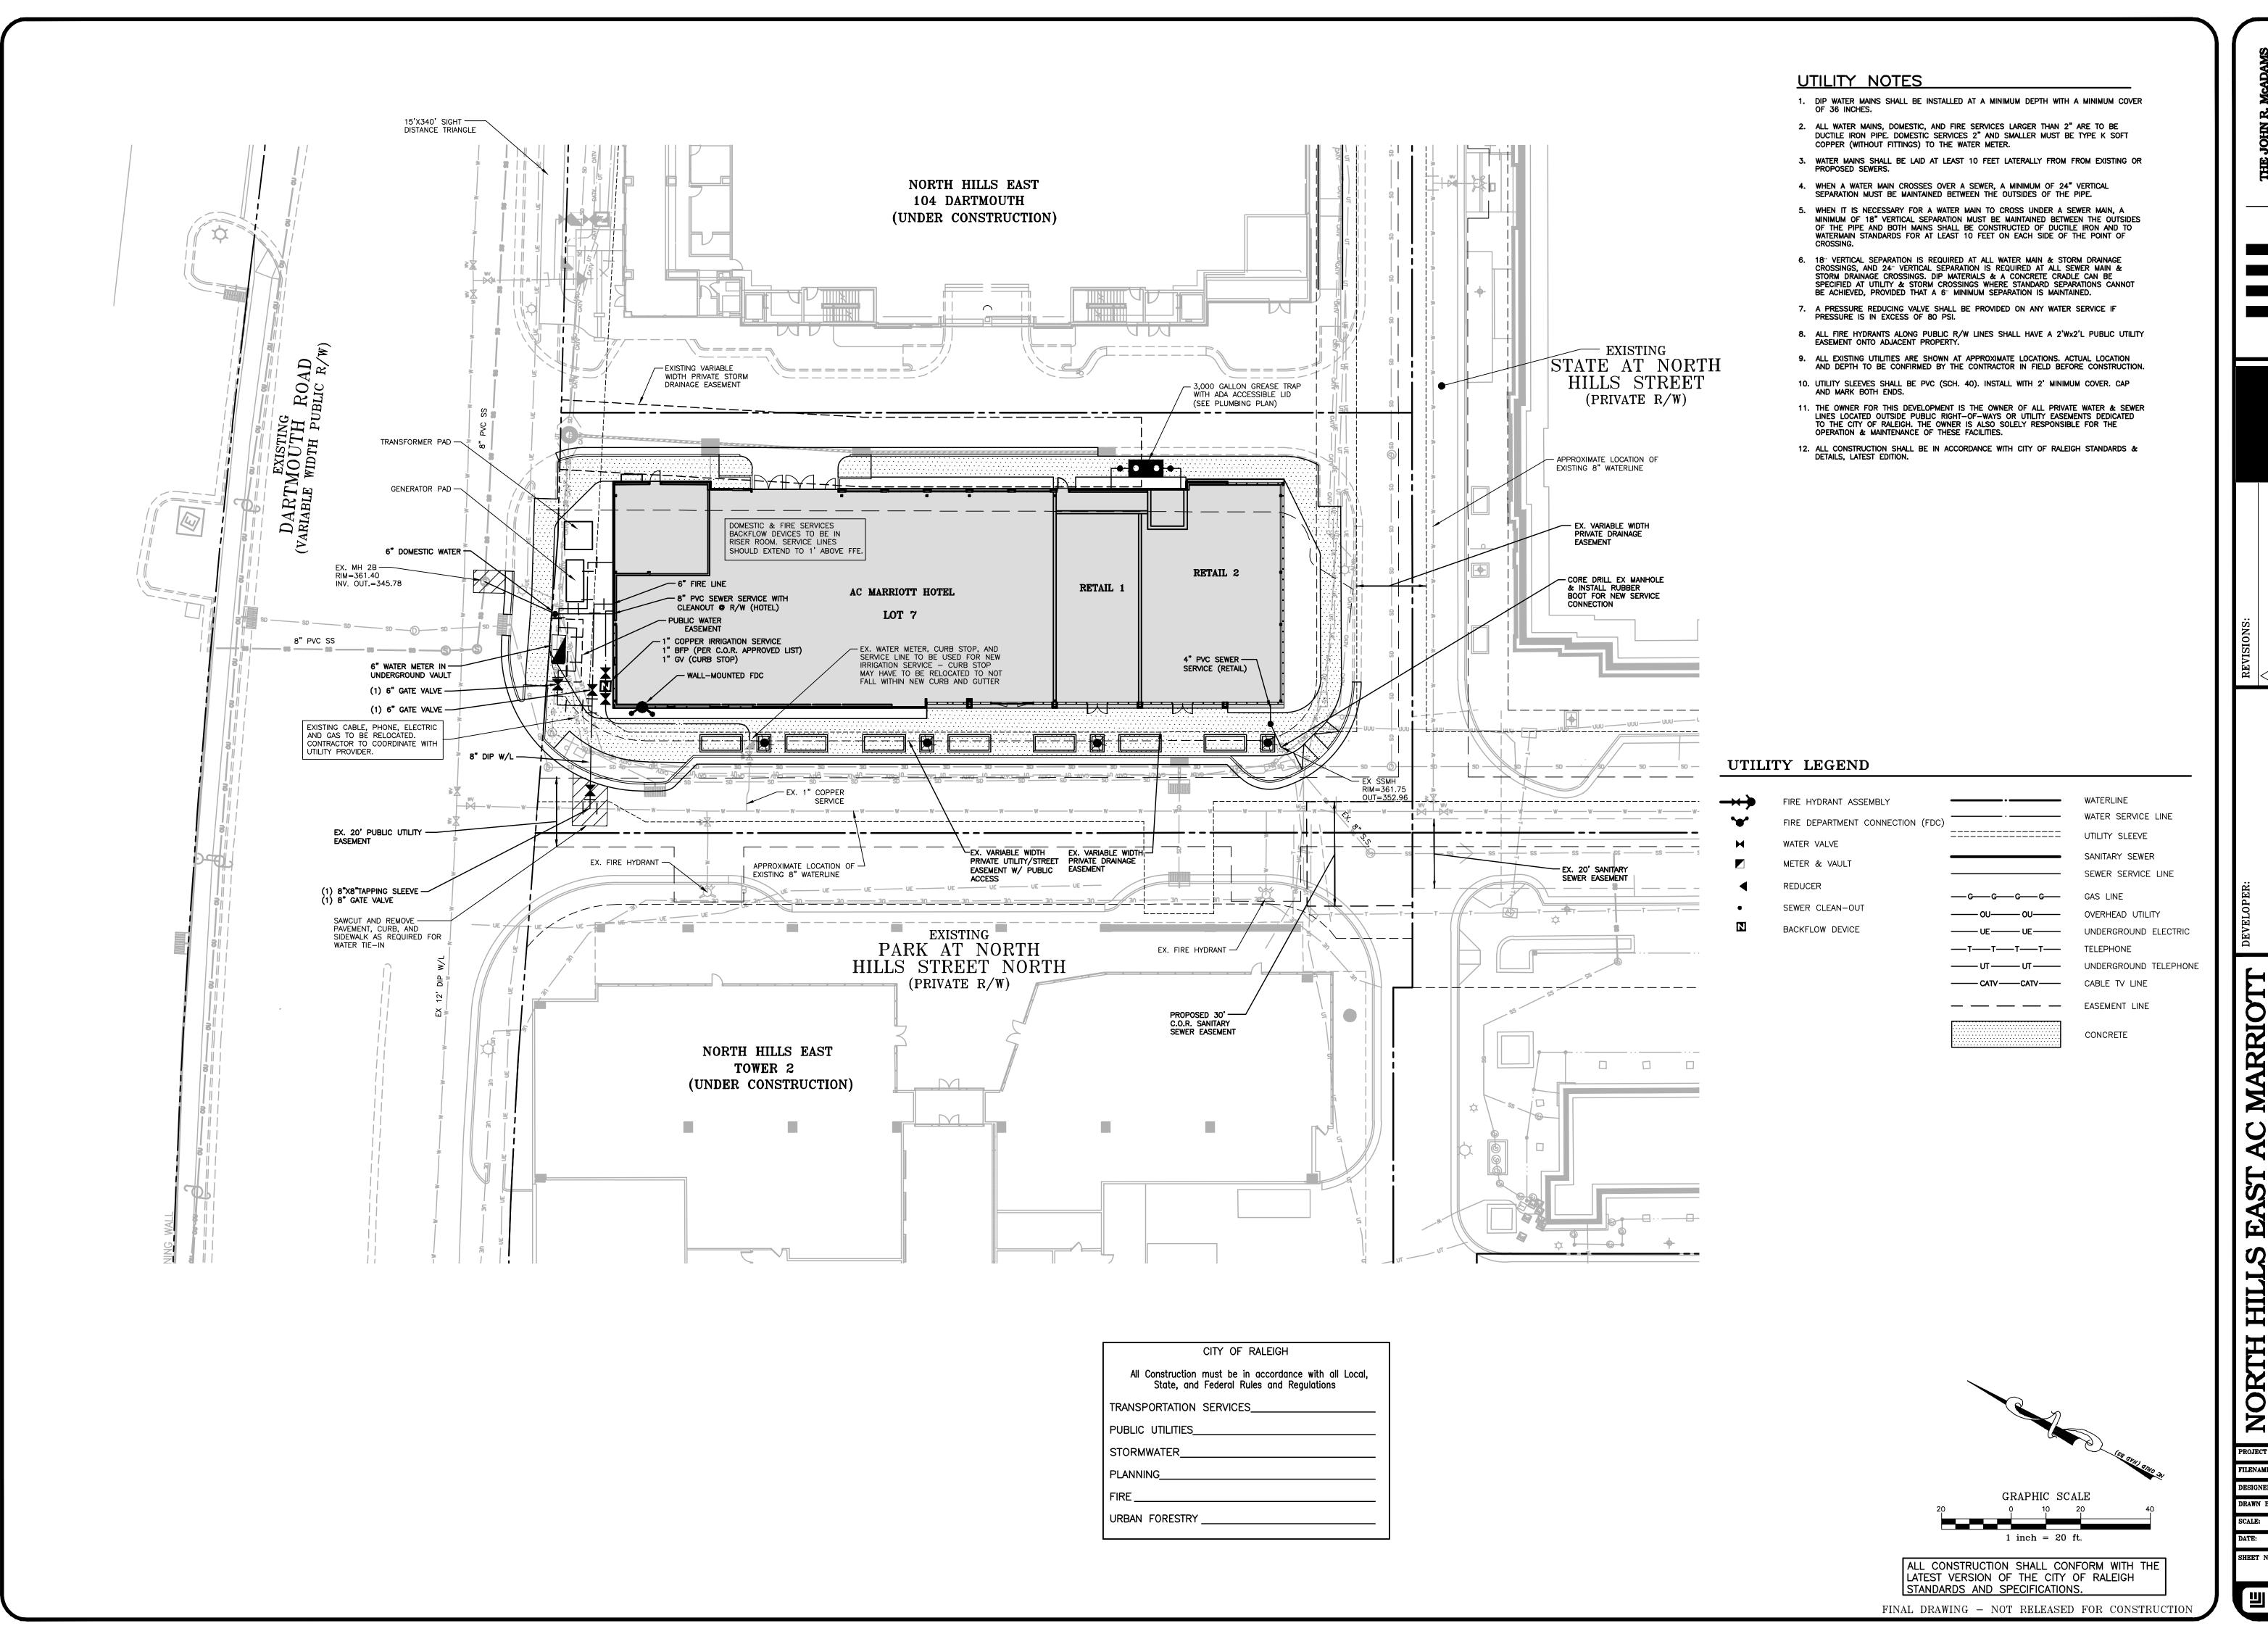


DRIV] WO, NO, NC

KANE CC EAST 410 COM RALEIG

PROJECT NO. DLR-14000 FILENAME:DLR14000—U1 DESIGNED BY: ARP NDW

1" = 20'07-01-2015

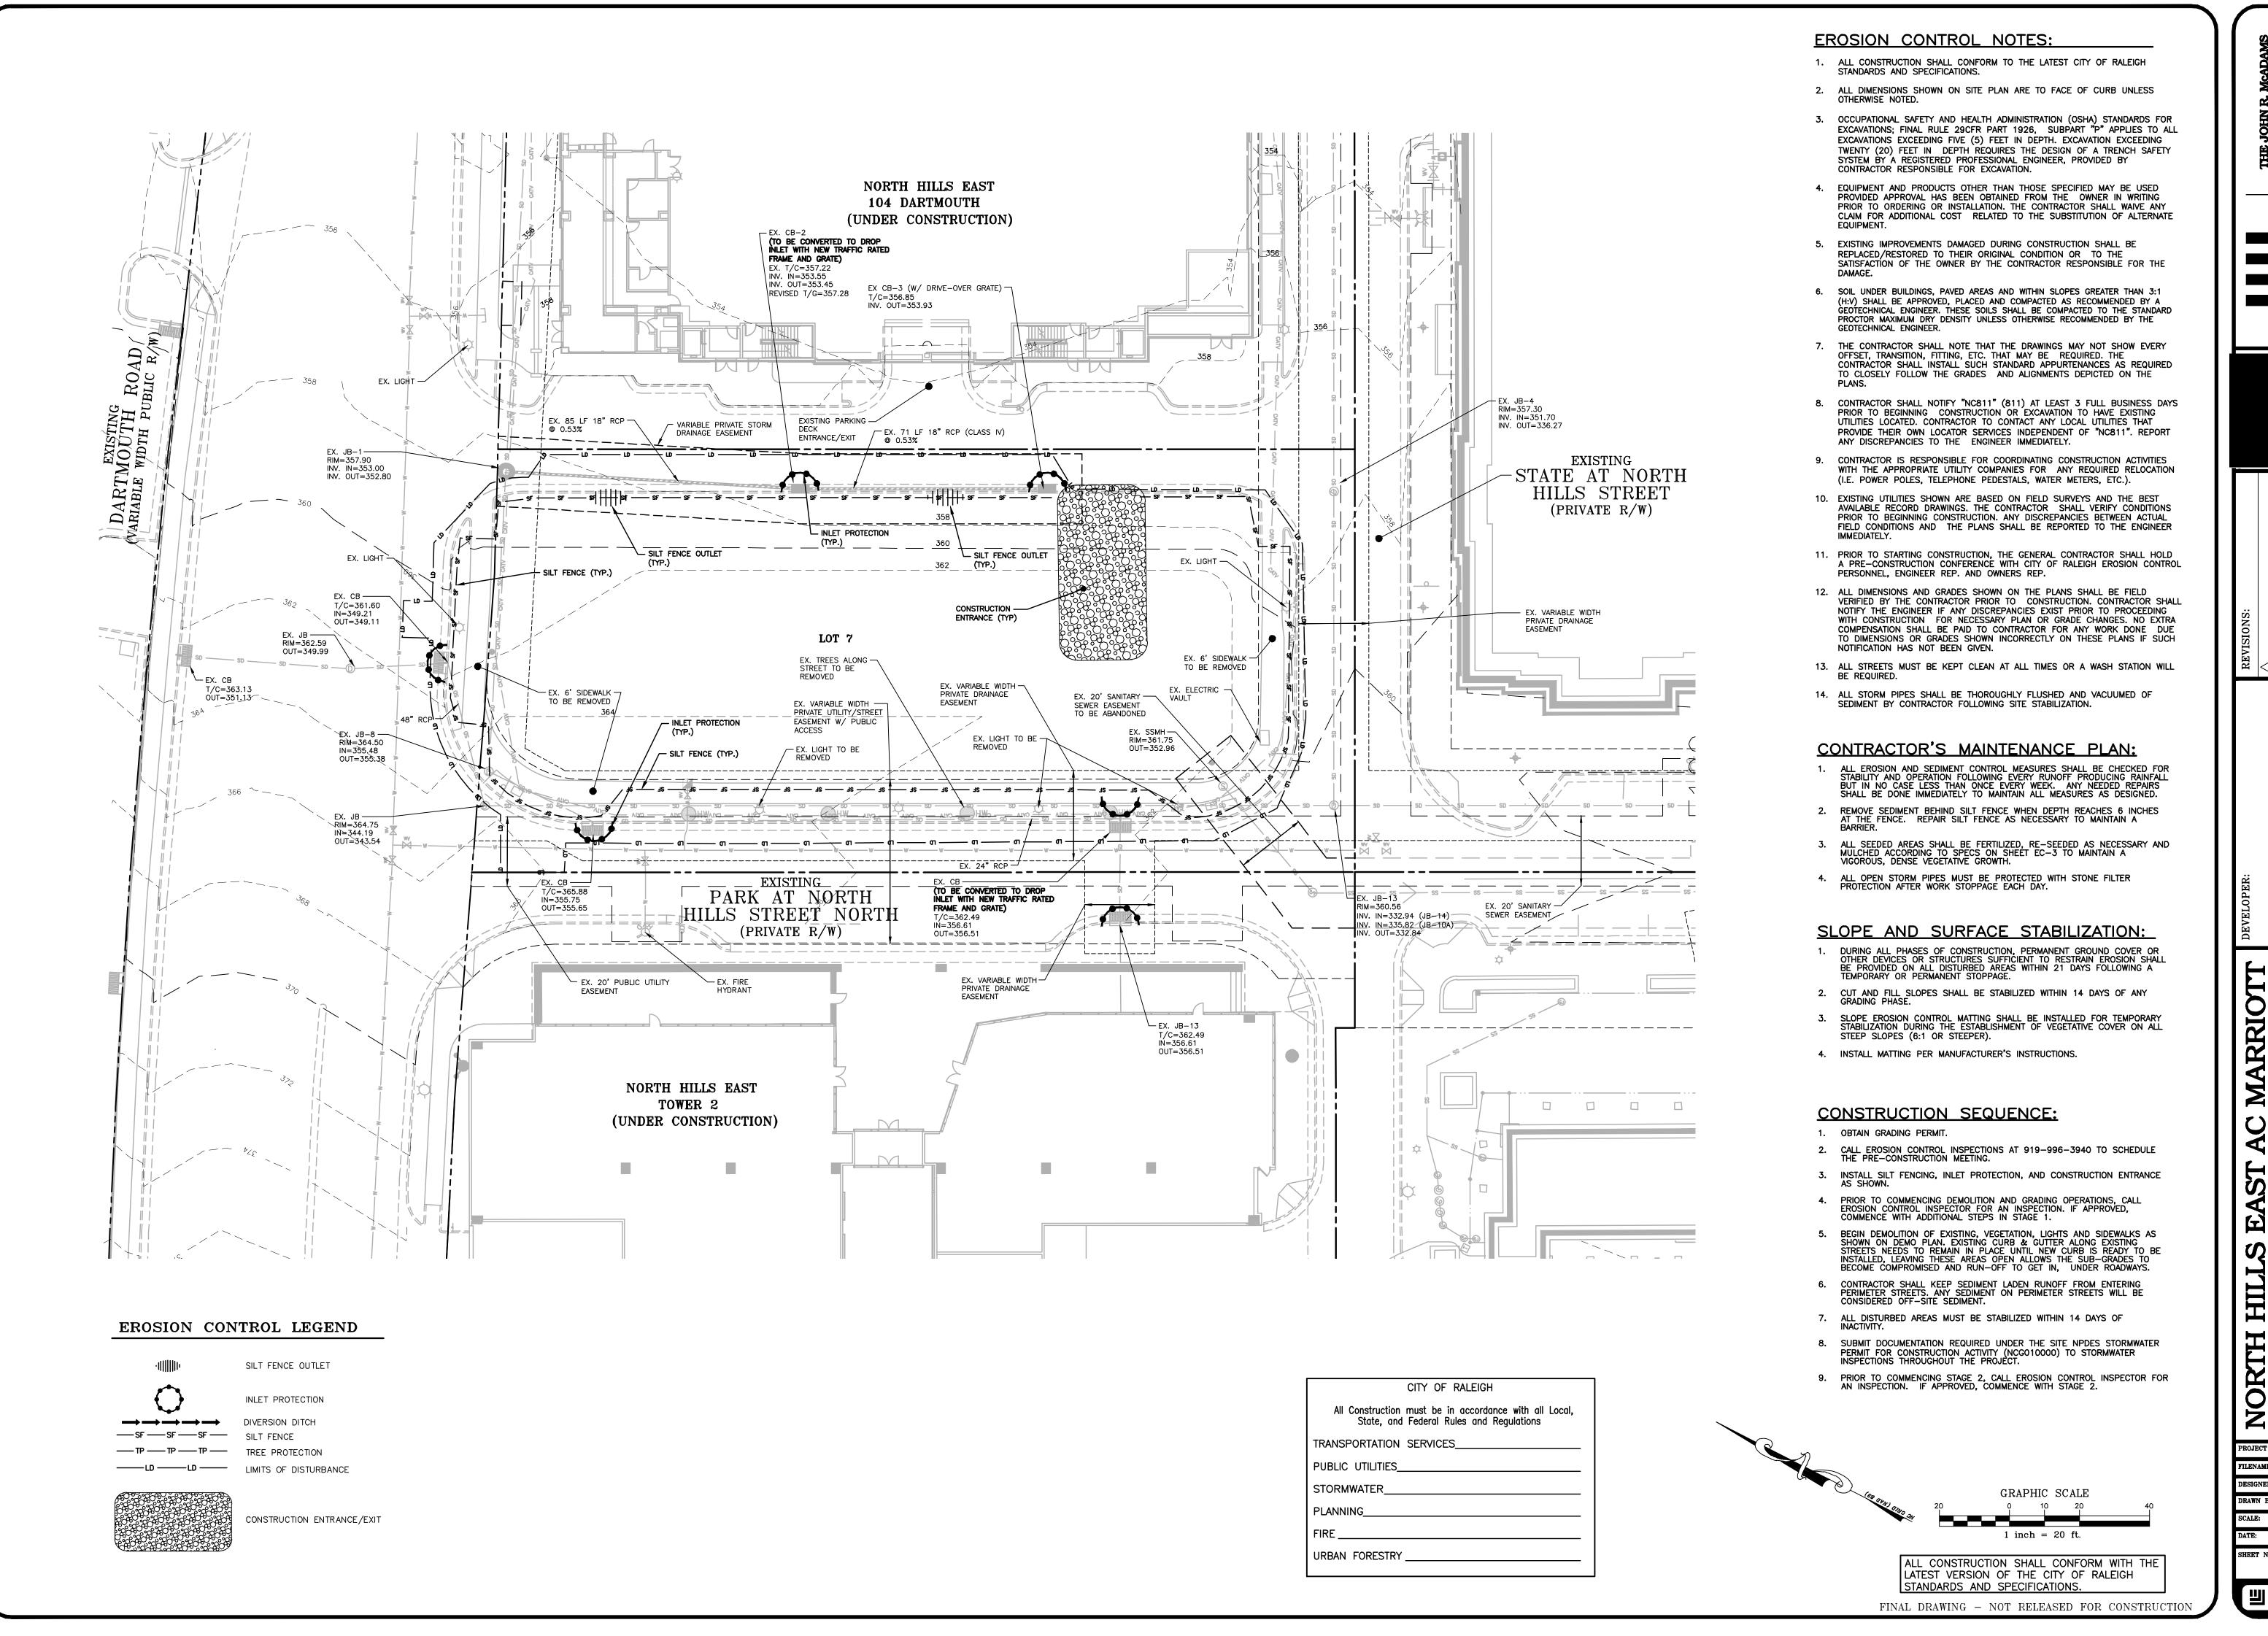

THE JOHN R. McADAMS
COMPANY, INC.
2905 Meridian Parkway
turham, North Carolina 2771

THE JOHN
COMPA
2905 Merid
Durham, North
License N
(800) 733-5646

MCADA

ANE CONCORD HOTEL EAST TWO, LLC 10 COMMON OAKS DRIV] RALEIGH, NC 27614

AST AC MARRIOTT
TH HILLS STREET
OUTH ROAD
WORTH CAROLINA

ARK AT NORTH
& DARTMOI
RALEIGH, NORTH

PROJECT NO. DLR-14000

FILENAME:DLR14000-EC1

DESIGNED BY: ARP

DRAWN BY: NDW

DENTITION LOT

DESIGNED BY: ARP


DRAWN BY: NDW

SCALE: 1" = 20'

DATE: 07-01-2015

SHEET NO. EC-

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DRIVI 14 OA WO, WO, NOAN

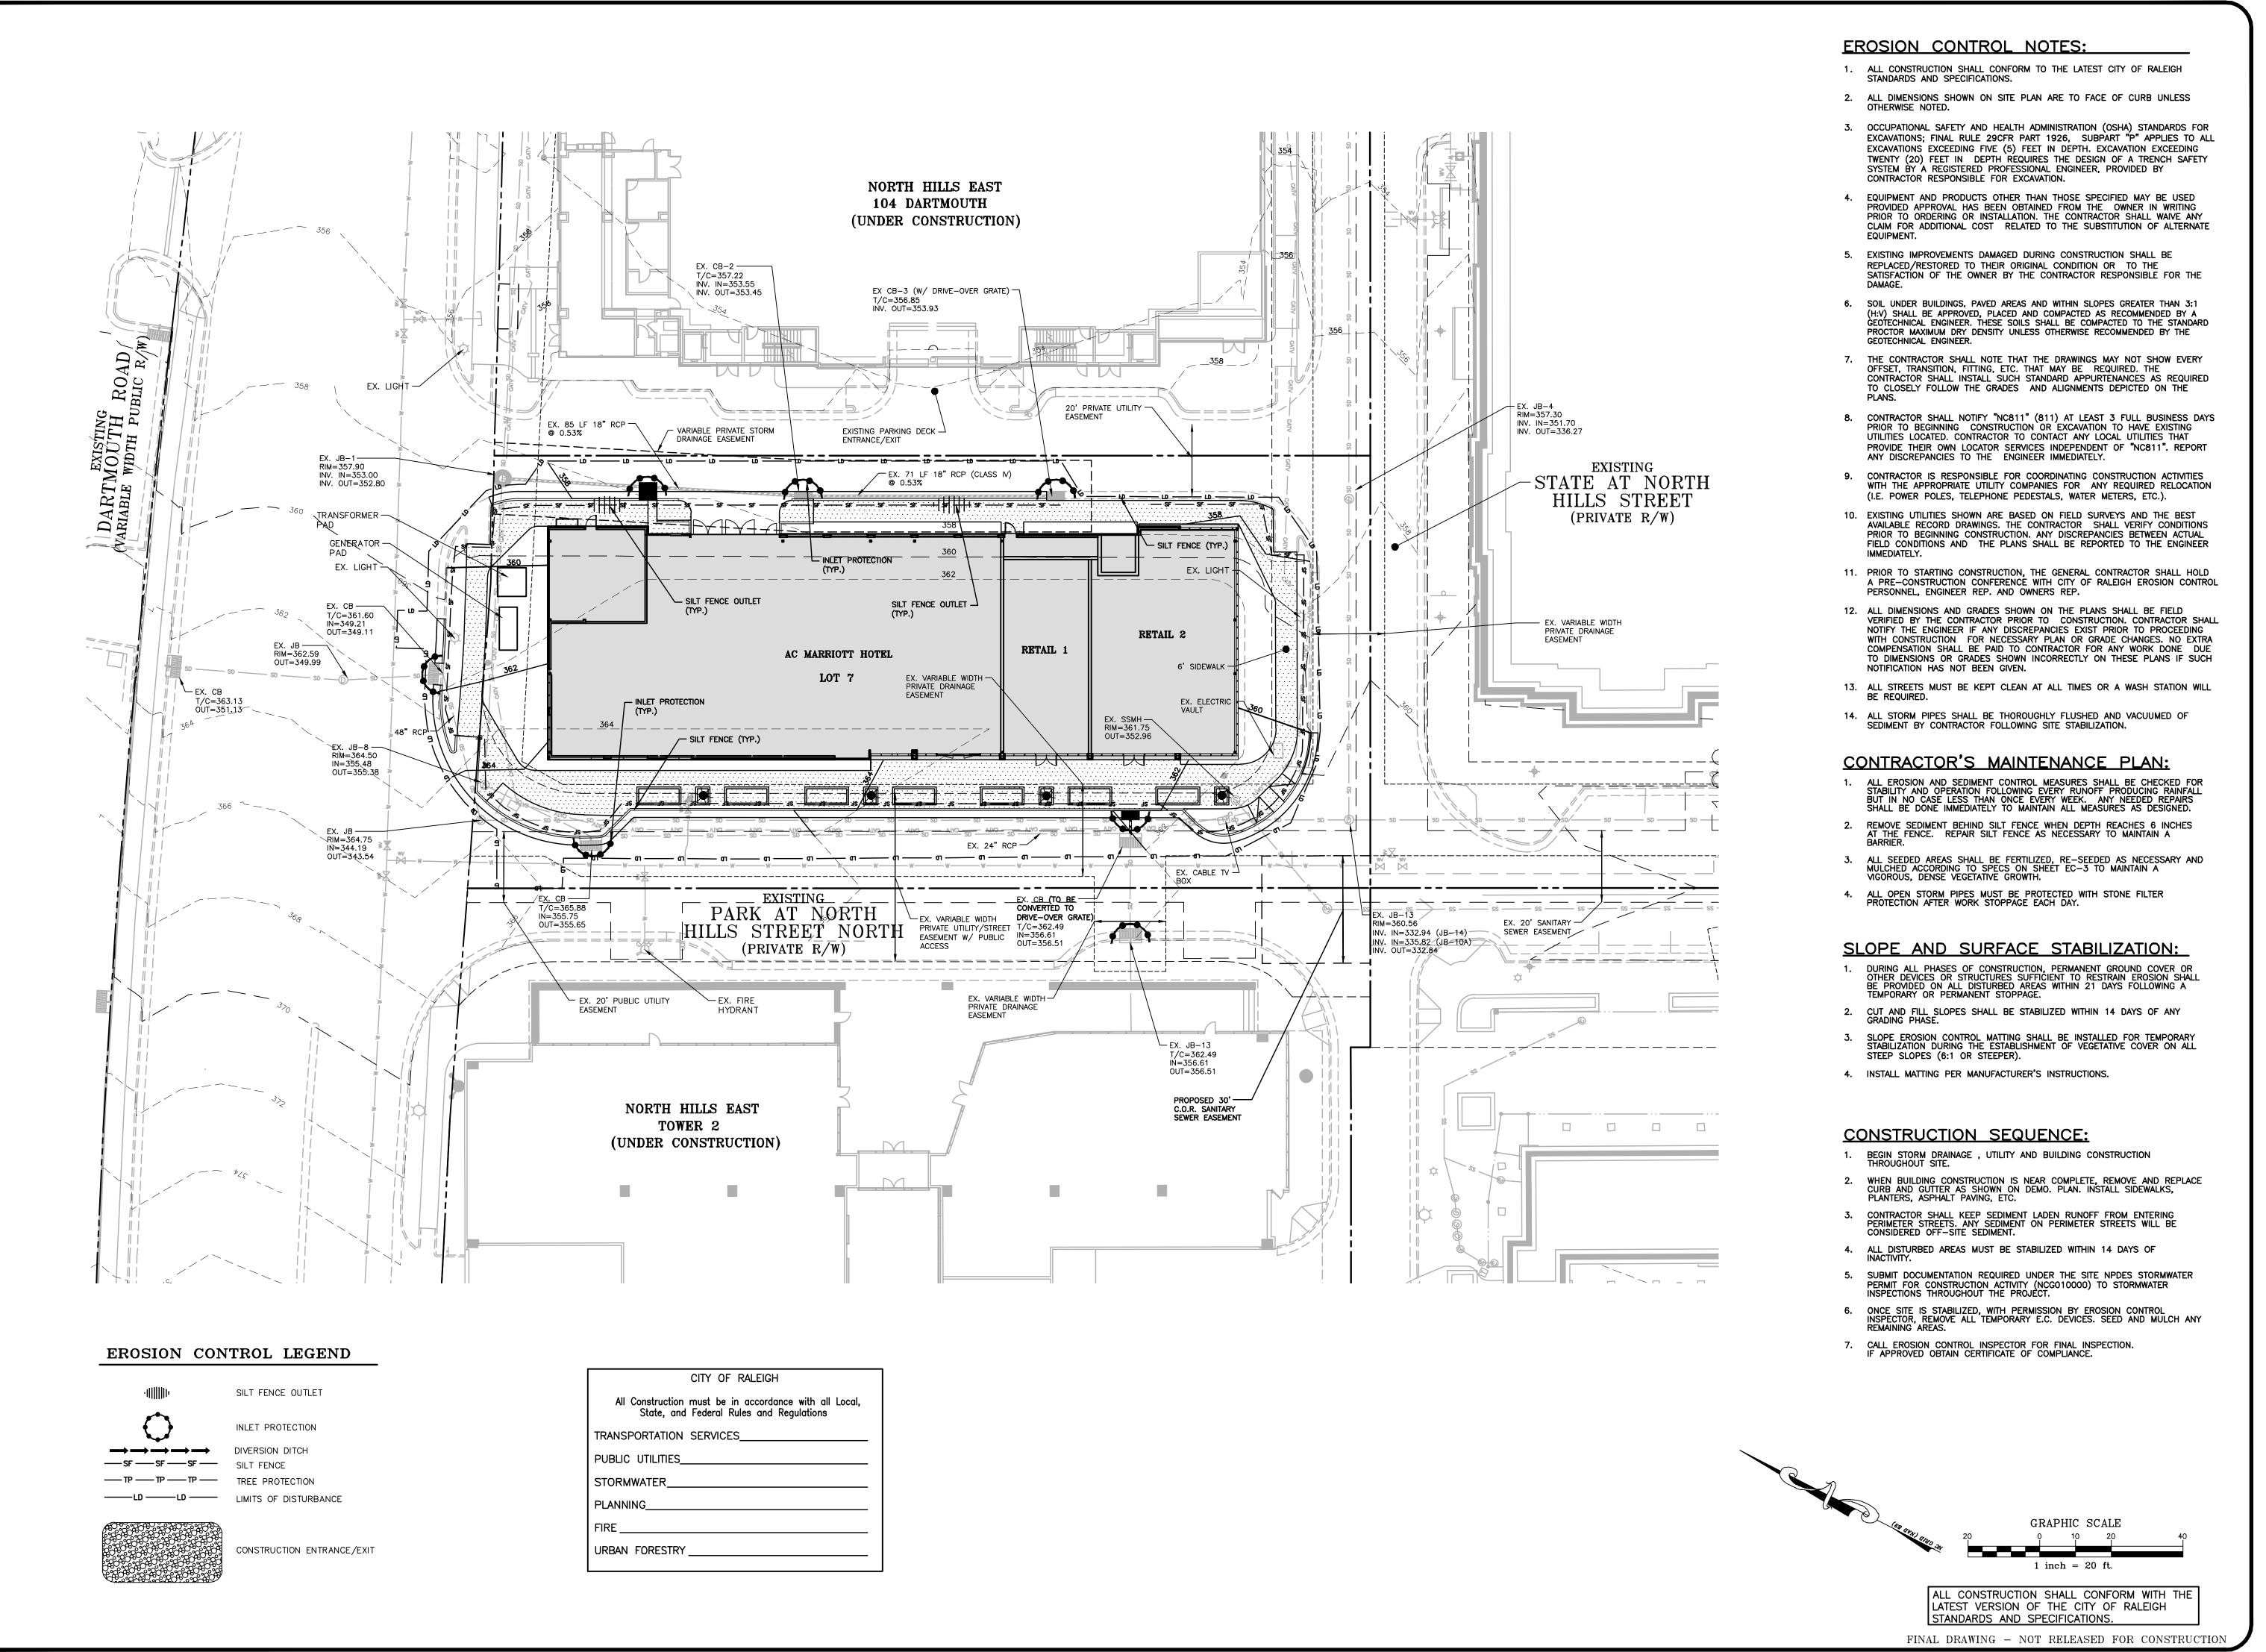I TW IMON IMON 0 RA

STREET

SAD


HILL KAT & D

PROJECT NO. DLR-14000 FILENAME:DLR14000-EC2 DESIGNED BY: ARP NDW 1" = 20'

07-01-2015

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EC-2

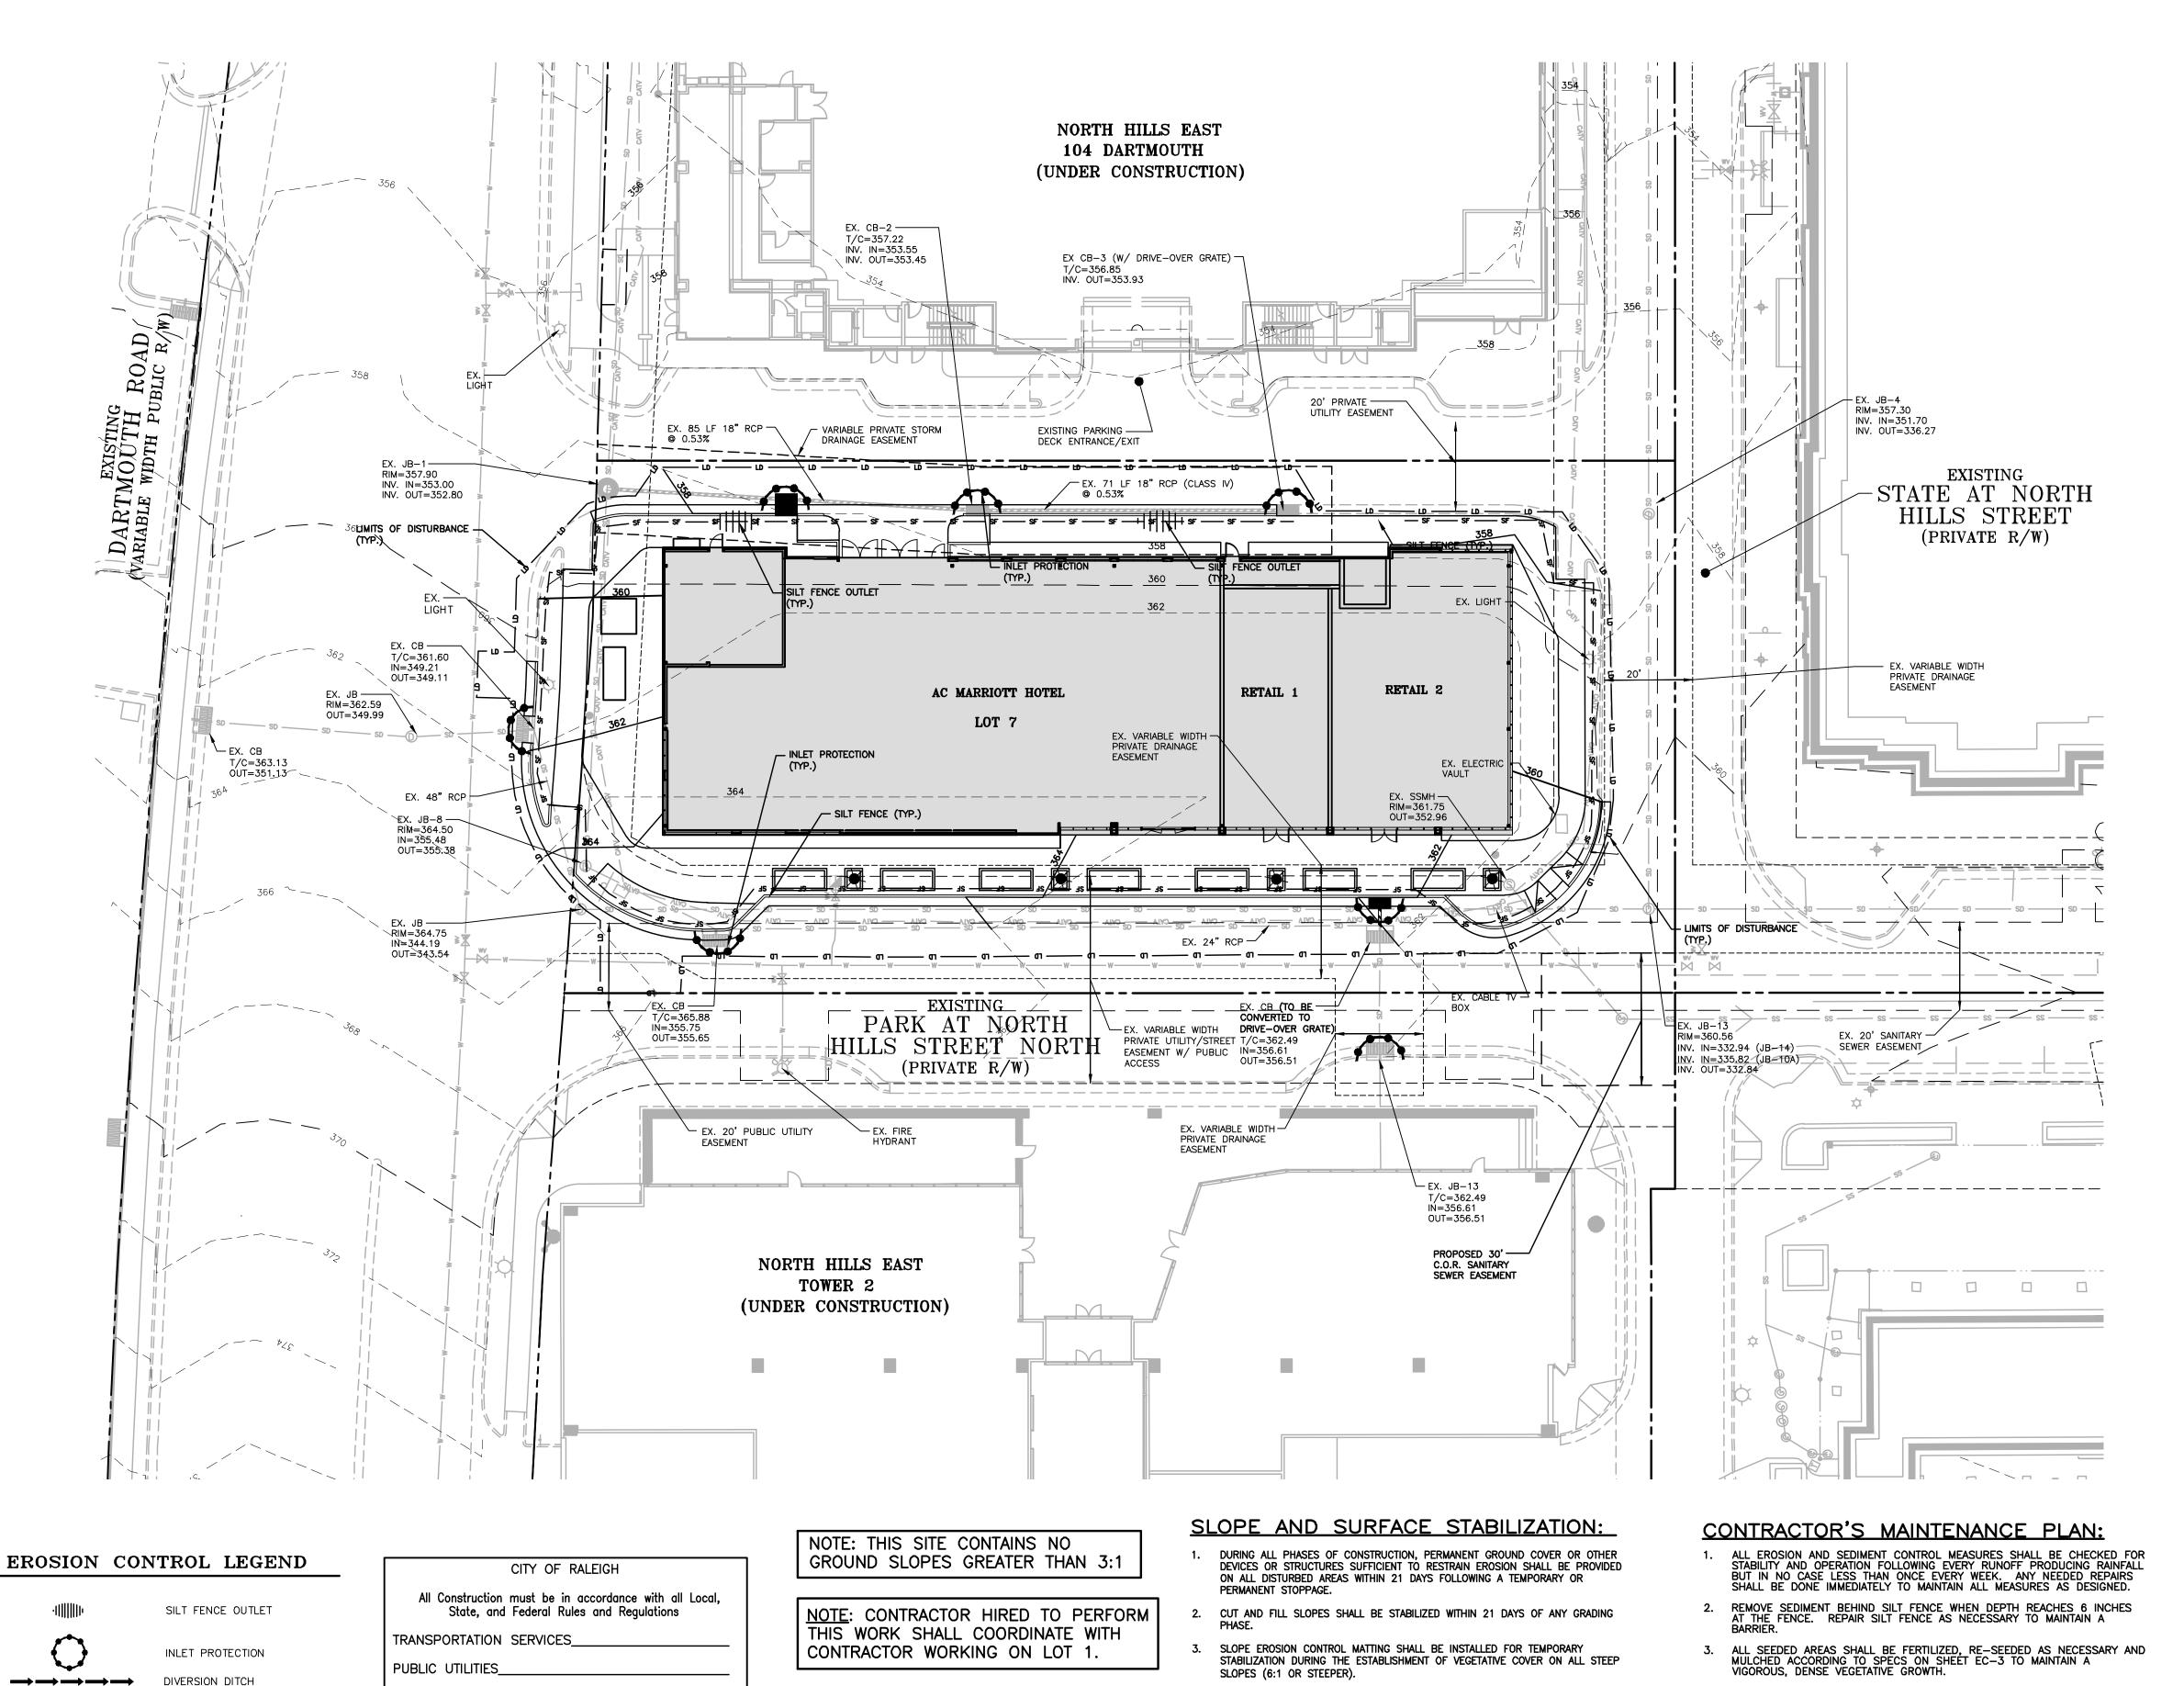

NOTE: GRADING PERMIT SHALL EXPIRE

TWO (2) YEARS FROM DATE ISSUED.

ACCORDANCE WITH THE CURRENT CITY

OF RALEIGH ENGINEERING DESIGN AND

ALL CONSTRUCTION SHALL BE IN

CONSTRUCTION STANDARDS

4. INSTALL MATTING PER MANUFACTURER'S INSTRUCTIONS.

STANDARD NPDES NOTES:

GENERAL STORMWATER PERMIT NCG010000 ONLY.

ENFORCEMENT ACTION UNDER THE CITY CODE.

PERMIT NCG010000.

THIS PAGE IS SUBMITTED TO COMPLY WITH NPDES GENERAL STORMWATER

THE CITY IS NOT AUTHORIZED TO ENFORCE THIS PAGE OF THE PLANS AND

THIS PAGE CAN BE APPROVED BY THE CITY PURSUANT TO NPDES

THIS PAGE OF THE APPROVED PLANS IS ENFORCEABLE EXCLUSIVELY

PURSUANT TO NPDES GENERAL STORMWATER PERMIT NCG010000.

IT IS NOT PART OF THE APPROVED PLANS FOR PURPOSES OF

STORMWATER_

URBAN FORESTRY

PLANNING

—— SF —— SF ——

——LD ——LD — LIMITS OF DISTURBANCE

CONSTRUCTION ENTRANCE/EXIT

EROSION CONTROL NOTES:

- 1. ALL CONSTRUCTION SHALL CONFORM TO THE LATEST CITY OF RALEIGH STANDARDS AND SPECIFICATIONS.
- 2. ALL DIMENSIONS SHOWN ON SITE PLAN ARE TO FACE OF CURB UNLESS
- 3. OCCUPATIONAL SAFETY AND HEALTH ADMINISTRATION (OSHA) STANDARDS FOR EXCAVATIONS; FINAL RULE 29CFR PART 1926, SUBPART "P" APPLIES TO ALL EXCAVATIONS EXCEEDING FIVE (5) FEET IN DEPTH. EXCAVATION EXCEEDING TWENTY (20) FEET IN DEPTH REQUIRES THE DESIGN OF A TRENCH SAFETY SYSTEM BY A REGISTERED PROFESSIONAL ENGINEER, PROVIDED BY CONTRACTOR RESPONSIBLE FOR EXCAVATION.
- 4. EQUIPMENT AND PRODUCTS OTHER THAN THOSE SPECIFIED MAY BE USED PROVIDED APPROVAL HAS BEEN OBTAINED FROM THE OWNER IN WRITING PRIOR TO ORDERING OR INSTALLATION. THE CONTRACTOR SHALL WAIVE ANY CLAIM FOR ADDITIONAL COST RELATED TO THE SUBSTITUTION OF ALTERNATE
- 5. EXISTING IMPROVEMENTS DAMAGED DURING CONSTRUCTION SHALL BE REPLACED/RESTORED TO THEIR ORIGINAL CONDITION OR TO THE SATISFACTION OF THE OWNER BY THE CONTRACTOR RESPONSIBLE FOR THE
- 6. SOIL UNDER BUILDINGS, PAVED AREAS AND WITHIN SLOPES GREATER THAN 3:1 (H:V) SHALL BE APPROVED, PLACED AND COMPACTED AS RECOMMENDED BY A GEOTECHNICAL ENGINEER. THESE SOILS SHALL BE COMPACTED TO THE STANDARD PROCTOR MAXIMUM DRY DENSITY UNLESS OTHERWISE RECOMMENDED BY THE GEOTECHNICAL ENGINEER.
- 7. THE CONTRACTOR SHALL NOTE THAT THE DRAWINGS MAY NOT SHOW EVERY OFFSET, TRANSITION, FITTING, ETC. THAT MAY BE REQUIRED. THE CONTRACTOR SHALL INSTALL SUCH STANDARD APPURTENANCES AS REQUIRED TO CLOSELY FOLLOW THE GRADES AND ALIGNMENTS DEPICTED ON THE
- 8. CONTRACTOR SHALL NOTIFY "NC811" (811) AT LEAST 3 FULL BUSINESS DAYS PRIOR TO BEGINNING CONSTRUCTION OR EXCAVATION TO HAVE EXISTING UTILITIES LOCATED. CONTRACTOR TO CONTACT ANY LOCAL UTILITIES THAT PROVIDE THEIR OWN LOCATOR SERVICES INDEPENDENT OF "NC811". REPORT ANY DISCREPANCIES TO THE ENGINEER IMMEDIATELY.
- 9. CONTRACTOR IS RESPONSIBLE FOR COORDINATING CONSTRUCTION ACTIVITIES WITH THE APPROPRIATE UTILITY COMPANIES FOR ANY REQUIRED RELOCATION (I.E. POWER POLES, TELEPHONE PEDESTALS, WATER METERS, ETC.).
- 10. EXISTING UTILITIES SHOWN ARE BASED ON FIELD SURVEYS AND THE BEST AVAILABLE RECORD DRAWINGS. THE CONTRACTOR SHALL VERIFY CONDITIONS PRIOR TO BEGINNING CONSTRUCTION. ANY DISCREPANCIES BETWEEN ACTUAL FIELD CONDITIONS AND THE PLANS SHALL BE REPORTED TO THE ENGINEER IMMEDIATELY.
- 11. PRIOR TO STARTING CONSTRUCTION, THE GENERAL CONTRACTOR SHALL HOLD A PRE-CONSTRUCTION CONFERENCE WITH CITY OF RALEIGH EROSION CONTROL PERSONNEL, ENGINEER REP. AND OWNERS REP.
- 12. ALL DIMENSIONS AND GRADES SHOWN ON THE PLANS SHALL BE FIELD VERIFIED BY THE CONTRACTOR PRIOR TO CONSTRUCTION, CONTRACTOR SHALL NOTIFY THE ENGINEER IF ANY DISCREPANCIES EXIST PRIOR TO PROCEEDING WITH CONSTRUCTION FOR NECESSARY PLAN OR GRADE CHANGES. NO EXTRA COMPENSATION SHALL BE PAID TO CONTRACTOR FOR ANY WORK DONE DUE TO DIMENSIONS OR GRADES SHOWN INCORRECTLY ON THESE PLANS IF SUCH NOTIFICATION HAS NOT BEEN GIVEN.
- 13. ALL STREETS MUST BE KEPT CLEAN AT ALL TIMES OR A WASH STATION WILL BE REQUIRED.
- 14. ALL STORM PIPES SHALL BE THOROUGHLY FLUSHED AND VACUUMED OF SEDIMENT BY CONTRACTOR FOLLOWING SITE STABILIZATION.

SEEDBED PREPARATION:

- 1. CHISEL COMPACTED AREAS AND SPREAD TOPSOIL THREE INCHES DEEP OVER ADVERSE SOIL CONDITIONS, IF AVAILABLE.
- 2. RIP THE ENTIRE AREA TO SIX INCHES DEEP.
- REMOVE ALL LOOSE ROCK, ROOTS AND OTHER OBSTRUCTIONS, LEAVING SURFACE REASONABLY SMOOTH AND UNIFORM.
- 4. APPLY AGRICULTURAL LIME, FERTILIZER AND SUPERPHOSPHATE UNIFORMLY AND MIX WITH SOIL. 5. CONTINUE TILLAGE UNTIL A WELL-PULVERIZED, FIRM, REASONABLY UNIFORM SEEDBED IS
- 6. SEED ON A FRESHLY PREPARED SEEDBED AND COVER SEED LIGHTLY WITH SEEDING EQUIPMENT OR CULTIPACK AFTER SEEDING.
- 7. MULCH IMMEDIATELY AFTER SEEDING AND ANCHOR MULCH.
- 8. INSPECT ALL SEEDED AREAS AND MAKE NECESSARY REPAIRS OR RESEEDINGS WITHIN THE PLANTING SEASON, IF POSSIBLE. IF STAND SHOULD BE MORE THAN 60% DAMAGED, RE-ESTABLISH FOLLOWING THE ORIGINAL LIME, FERTILIZER AND SEEDING RATES.
- 9. CONSULT S&EC ENVIRONMENTAL ENGINEERS ON MAINTENANCE TREATMENT AND FERTILIZATION AFTER PERMANENT COVER IS ESTABLISHED.

MIXTURE

ALL OPEN STORM PIPES MUST BE PROTECTED WITH STONE FILTER PROTECTION AFTER WORK STOPPAGE EACH DAY.

AGRICULTURAL LIMESTONE 2 TONS/ACRE (3 TONS/ACRE IN CLAY SOILS) FERTILIZER 1,000 LBS/ACRE - 10-10-10 SUPERPHOSPHATE 500 LBS/ACRE - 20% ANALYSIS MULCH 2 TONS/ACRE - SMALL GRAIN STRAW ASPHALT EMULSION AT 300 GALS/ACRE ANCHOR

SEEDING SCHEDULE

FOR SHOULDERS, SIDE DITCHES, SLOPES (MAX 3:1)

NOV 1 - MAR 1 TALL FESCUE & ABRUZZI RYE MAR 1 - APR 15 TALL FESCUE

300 LBS/ACRE APR 15 - JUN 20 HULLED COMMON BERMUDAGRASS 25 LBS/ACRE 125 LBS/ACRE (TALL FESCUE) JUL 1 - AUG 15 TALL FESCUE AND BROWNTOPMILLET OR SORGHUM-SUDAN HYBRIDS*** 35 LBS/ACRE (BROWNTOP MILLET) 30 LBS/ACRE (SORGHUM-SUDAN HYB)

FOR SHOULDERS, SIDE DITCHES, SLOPES (MAX 3:1)


SERICEA LESPEDEZA (SCARIFIED) AND USE 50 LBS/ACRE (SERICEA LESPEDEZA) THE FOLLOWING COMBINATIONS

300 LBS/ACRE

120 LBS/ACRE ADD TALL FESCUE MAR 1 - JUN 30 OR ADD WEEPING LOVE GRASS 10 LBS/ACRE OR ADD HULLED COMMON BERMUDAGRASS 25 LBS/ACRE TALL FESCUE AND BROWTOP MILLET 120 LBS/ACRE (TALL FESCUE) OR SORGHUM-SUDAN HYBRIDS***

35 LBS/ACRE (BROWNTOP MILLET) 30 LBS/ACRE (SORGHUM-SUDAN HYB) IED) 70 LBS/ACRE (SERICA LESPEDEZA) SERICEA LESPEDEZA (UNHULLED-UNSC AND TALL FESCUE 120 LBS/ACRE (TALL FESCUE) 25 LBS/ACRE

*** TEMPORARY: RESEED ACCORDING TO OPTIMUM SEASON FOR DESIRED PERMANENT VEGETATION. DO NOT ALLOW TEMPORARY COVER TO GROW MORE THAN 12" IN HEIGHT BEFORE MOWING; OTHERWISE,

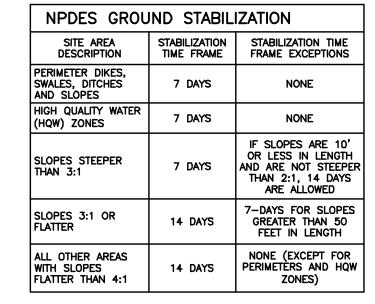

GRAPHIC SCALE 1 inch = 20 ft.

FINAL DRAWING - NOT RELEASED FOR CONSTRUCTION

HILL PROJECT NO. DLR-14000

STREET

SAD

DRIV 14

0 R

FILENAME:DLR14000-EC3 DESIGNED BY: ARP NDW 1" = 20'07-01-2015

EC-3

MCADAMS

NOTES:

PUBLIC ROAD.

RESPONSIBILITY FORM.

25' OR FULL WIDTH

OR ENTRANCE,

WHICHEVER IS

GREATER.

OF PROPOSED STREET

FABRIC UNDER STONE

CROSS SECTION

CONSTRUCTION ENTRANCE

BUT SUFFICIENT TO KEEP SEDIMENT ON SITE

2' - 3' STONE TO BE USED

RAILROAD BALAST)

<u>PLAN</u>

EXISTING ROADWAY

6" MIN.

(SURGE STONE OR

I. PUT SILT FENCE OR TREE PROTECTION FENCE UP TO ENSURE CONSTRUCTION ENTRANCE IS USED.


2. IF CONSTRUCTION ON THE SITES ARE SUCH THAT


VEHICLE MUST BE WASHED BEFORE ENTERING THE

3. IF A PROJECT CONTINUES TO PULL MUD AND DEBRIS ON TO THE PUBLIC ROAD, THE GOVERNING AUTHORITY WILL CLEAN THE AREA AND INVOICE THE FINANCIALLY RESPONSIBLE PERSON AS INDICATED ON THE FINANCIAL

NEW CONSTRUCTION

OVER THE STONE, THEN THE TIRES OF THE

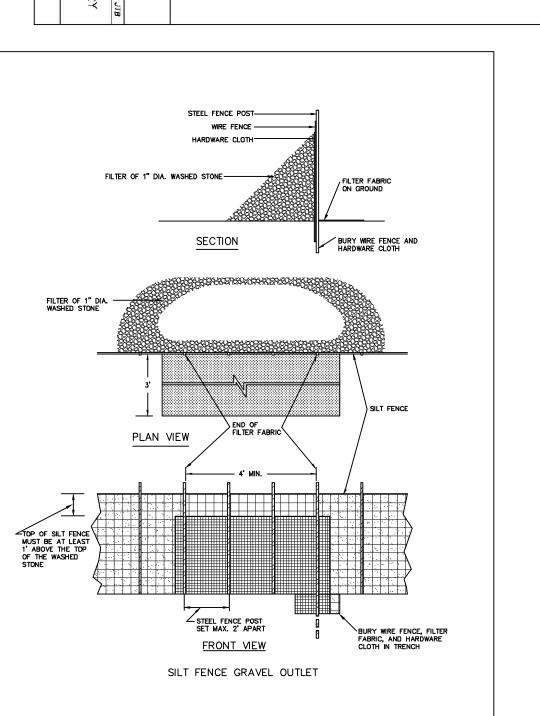

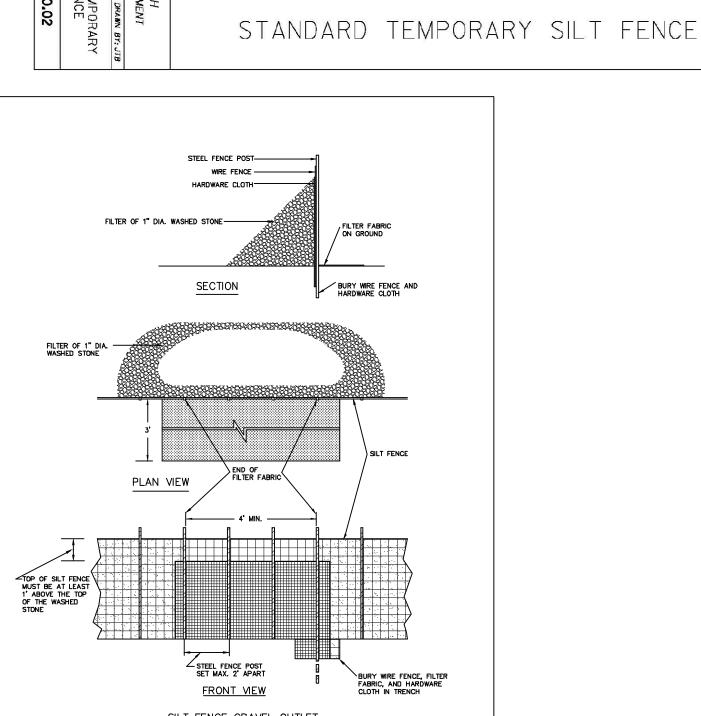

VARIABLE AS DIRECTED BY THE ENGINEER

SILT FENCE FABRIC
INSTALLED TO SECOND WIRE FROM TOP

FRONT VIEW

SIDE VIEW

WOVEN WIRE FABRIC IS ALWAYS REQUIRED
SILT FENCE GEOTEXTILE FABRIC

∼ 6" WIN. COVER * OVER \$KIRT

ANCOR SKIRT AS


DIRECTED BY ENGINEER. *

FOR REPAIR OF SILT FENCE FAILURES, USE No. 57 WASHED STONE.

FOR ANCHOR WHEN SILT FENCE IS PROTECTING CATCH BASIN. IN EACH CASE THE SILT FENCE IS TO BE PROPERLY

ENTRENCHED & THE STONE SHALL BE AT A MINIMUM OF 16"

ABOVE GRADE AT THE DIRECTION OF FLOW & BETWEEN 60 - 45 DEGREES.

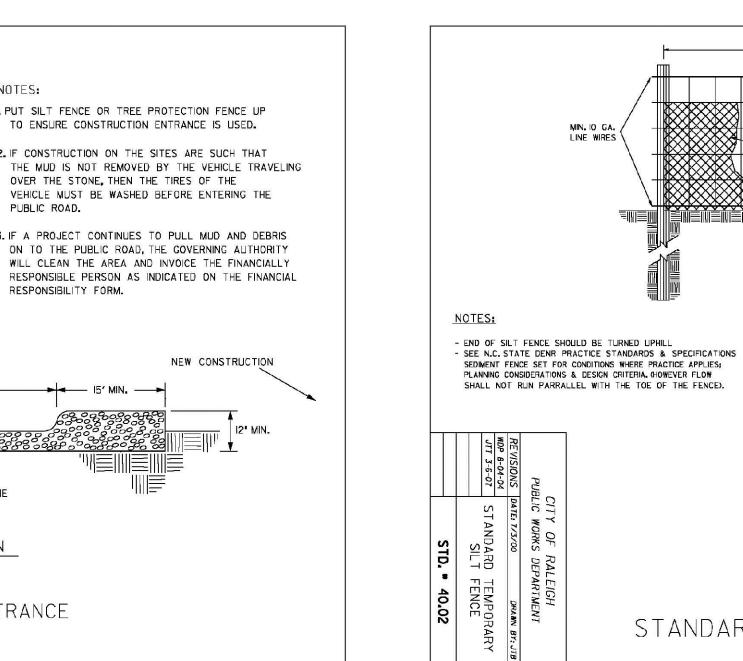

MARRIOTT HILL

KANE CONCORD HOTEL
EAST TWO, LLC
1410 COMMON OAKS DRIVE
RALEIGH, NC 27614

07-01-2015 EC-4 **벨McAdams**

NDW NTS

PROJECT NO. DLR-14000

FILENAME:DLR14000—EC4 DESIGNED BY: ARP

FINAL DRAWING - NOT RELEASED FOR CONSTRUCTION

CITY OF RALEIGH


All Construction must be in accordance with all Local, State, and Federal Rules and Regulations

TRANSPORTATION SERVICES_

PUBLIC UTILITIES_

URBAN FORESTRY


STORMWATER

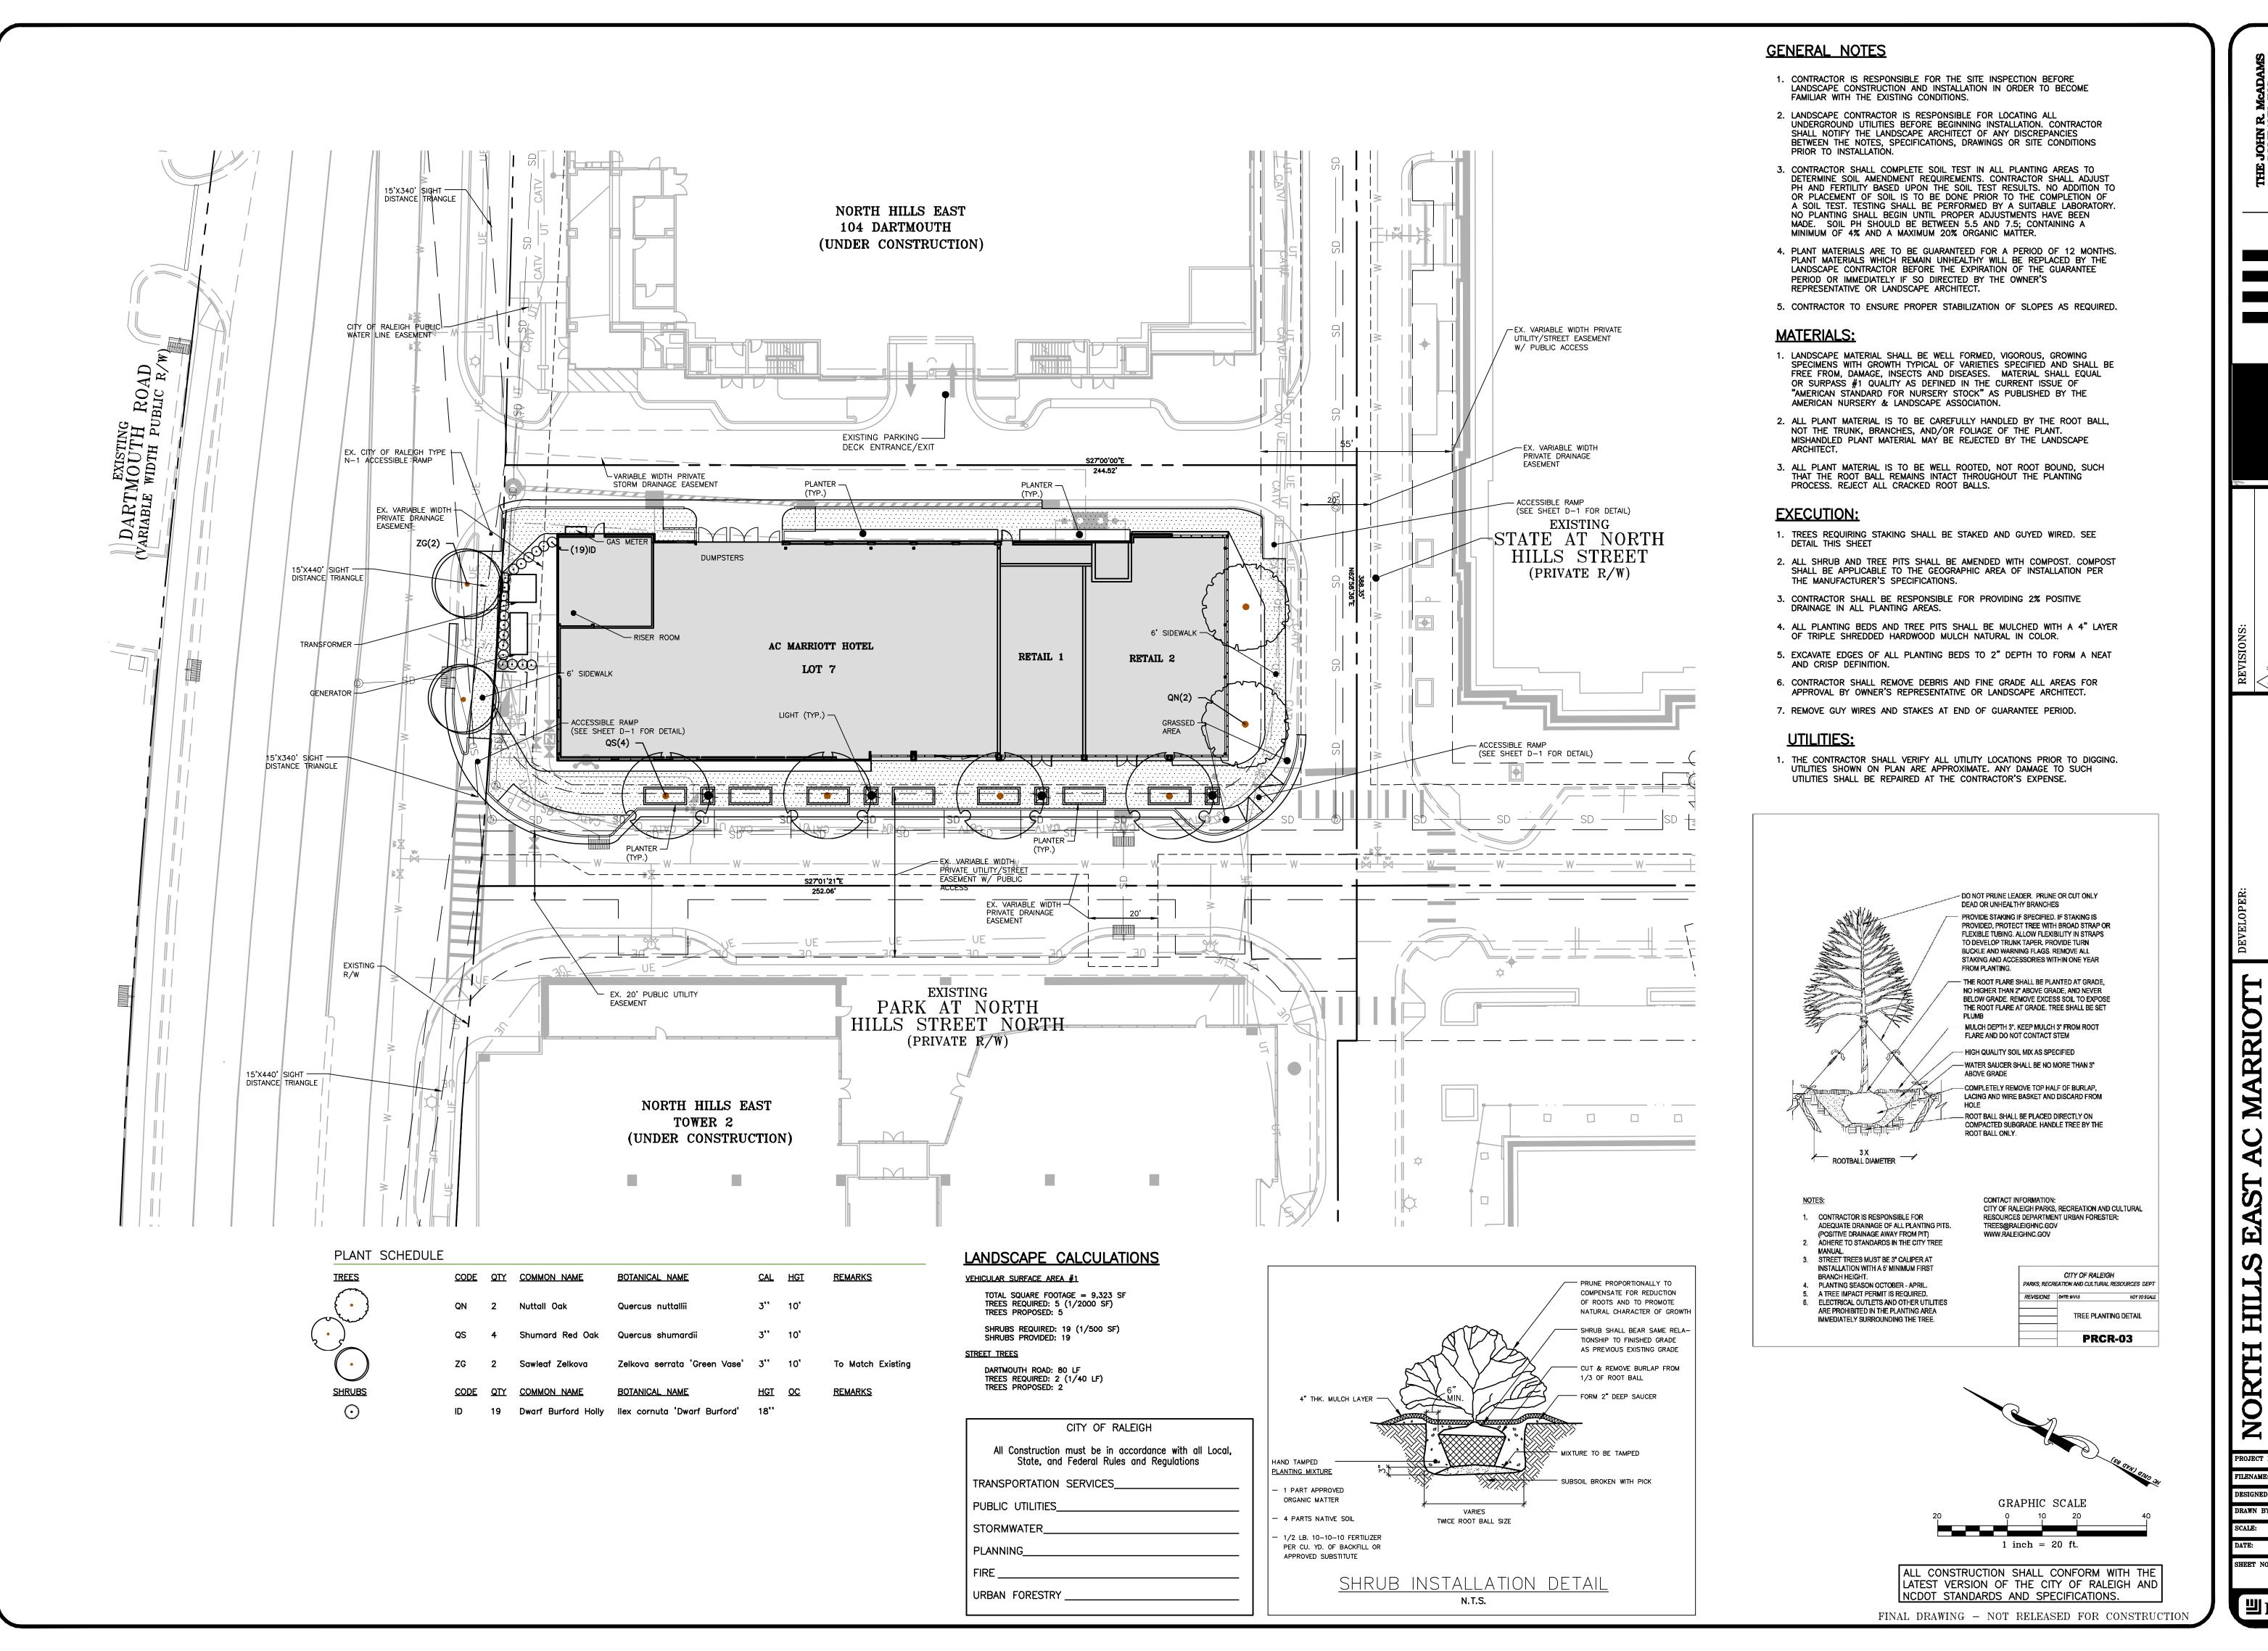



DRIV [4 WO, WO, NOA 0 2

PROJECT NO. DLR-14000 FILENAME:DLR14000—LS1 DESIGNED BY: ARP NDW 1" = 20'07-01-2015

LS-

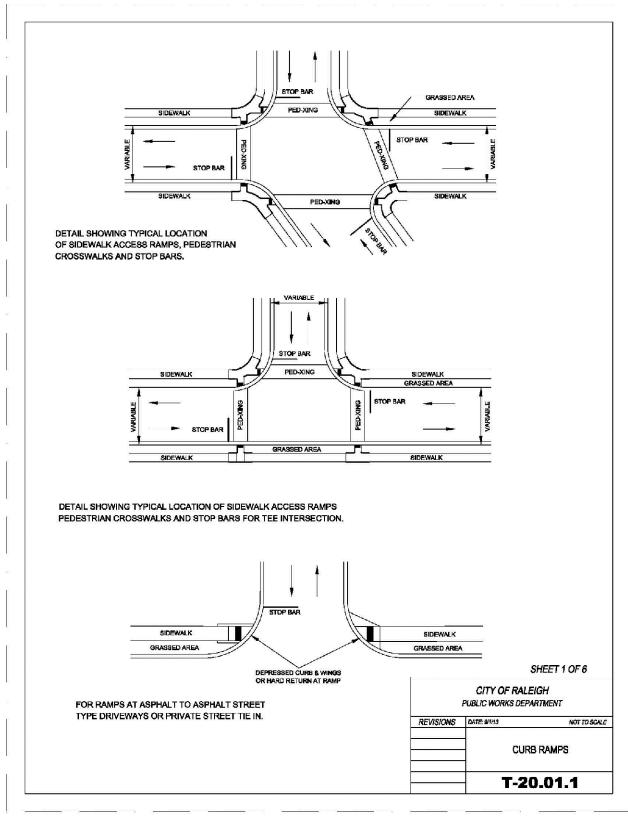

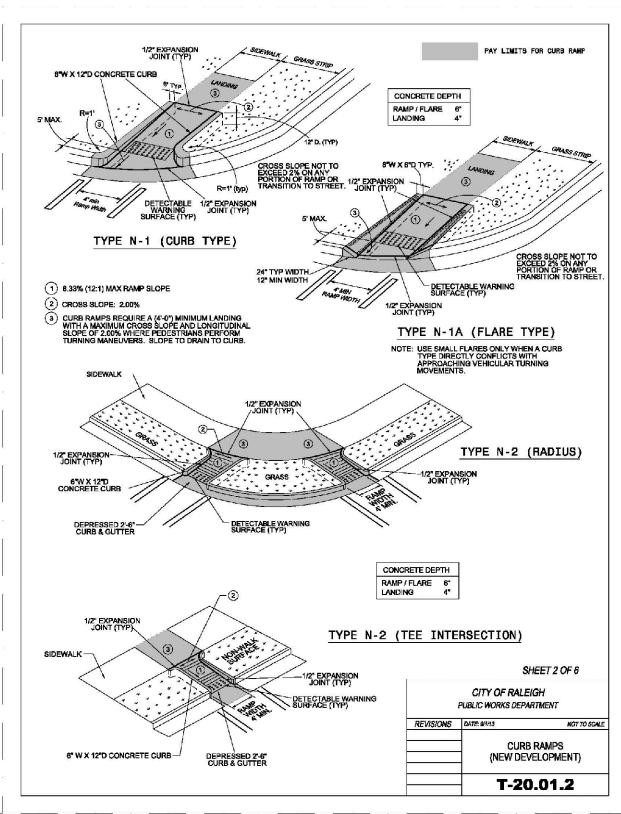

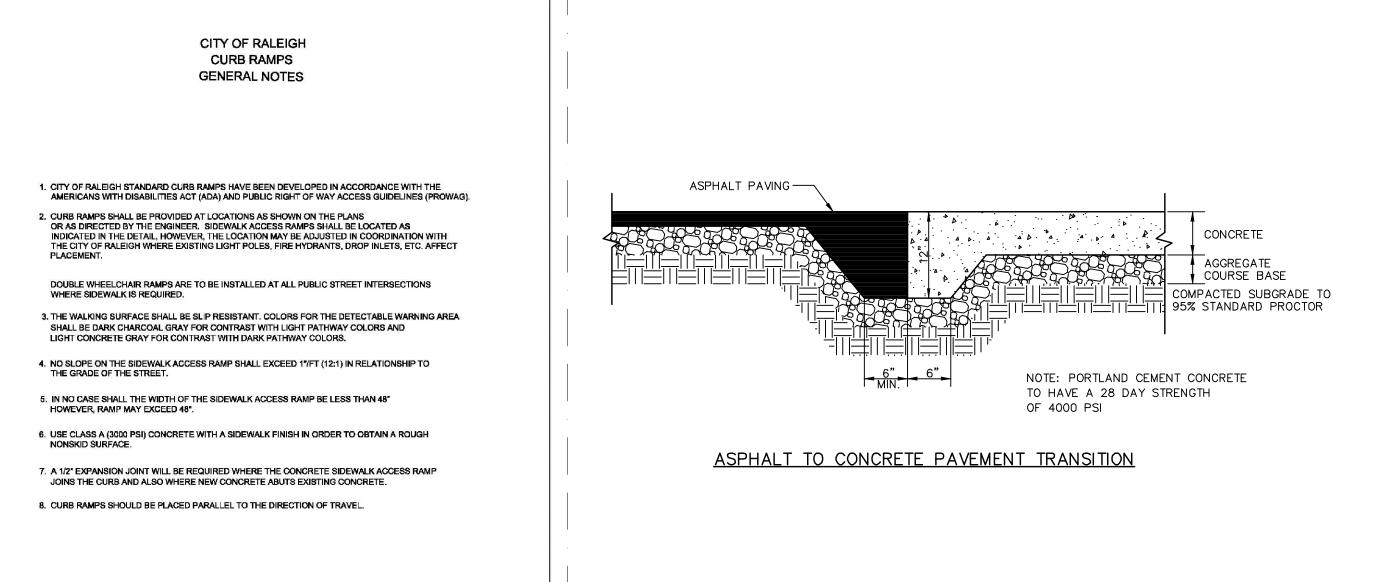



SHEET 6 OF 6


CITY OF RALEIGH


PUBLIC WORKS DEPARTMENT

CURB RAMP NOTES

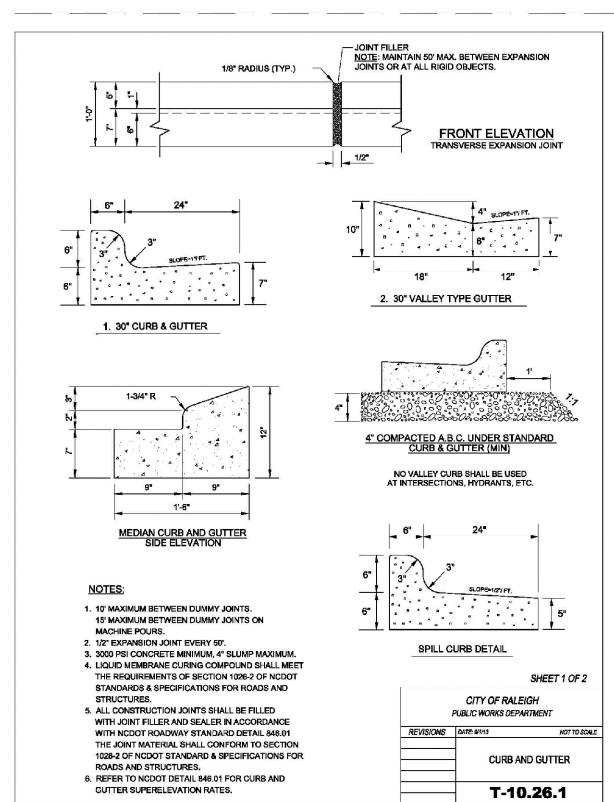

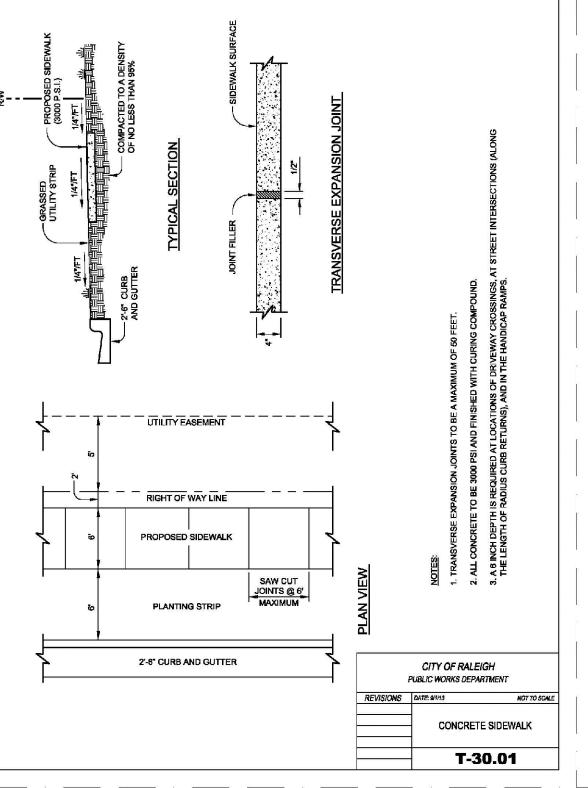

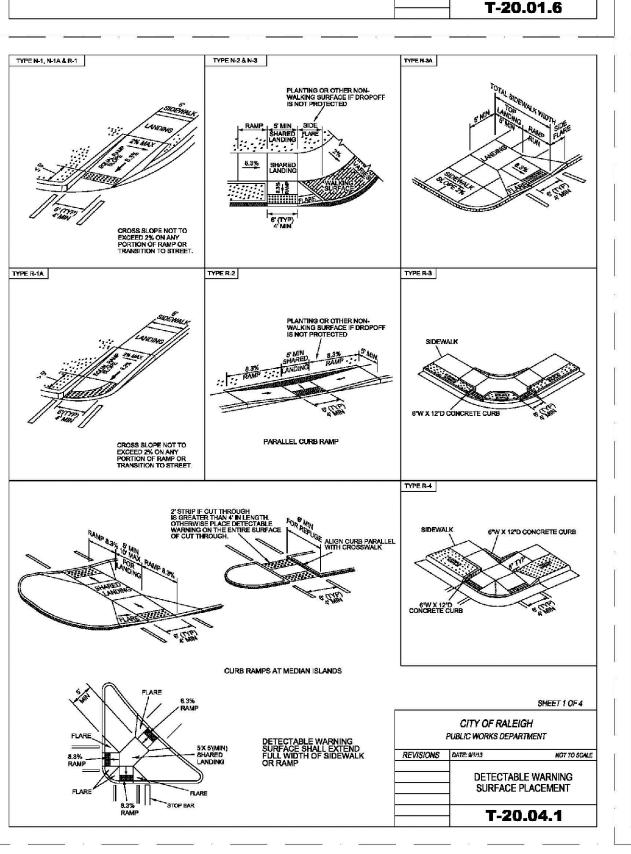


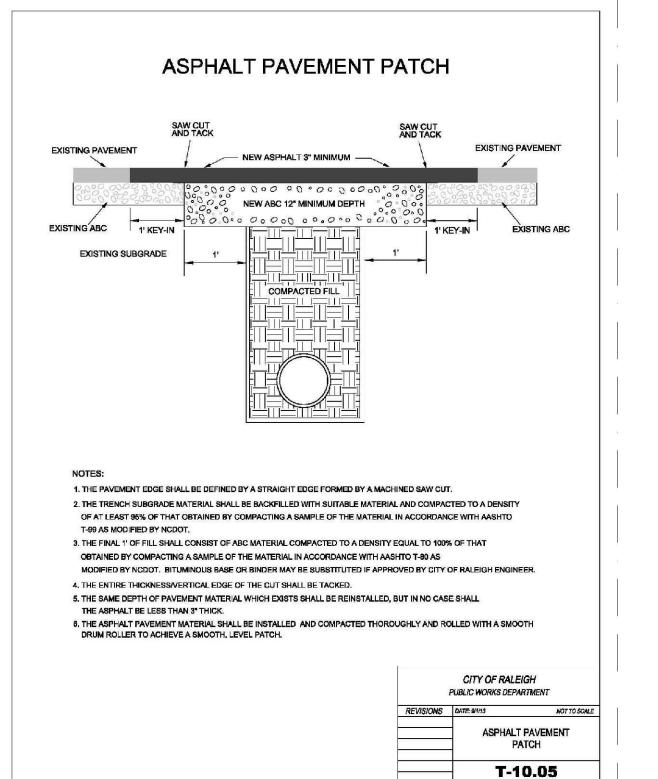



CITY OF RALEIGH
All Construction must be in accordance with all Local, State, and Federal Rules and Regulations
TRANSPORTATION SERVICES
PUBLIC UTILITIES
STORMWATER
PLANNING
FIRE
URBAN FORESTRY


DRIVI [4


PROJECT NO. DLR-14000 FILENAME:DLR14000—D1 DESIGNED BY: ARP NDW NTS 07-01-2015

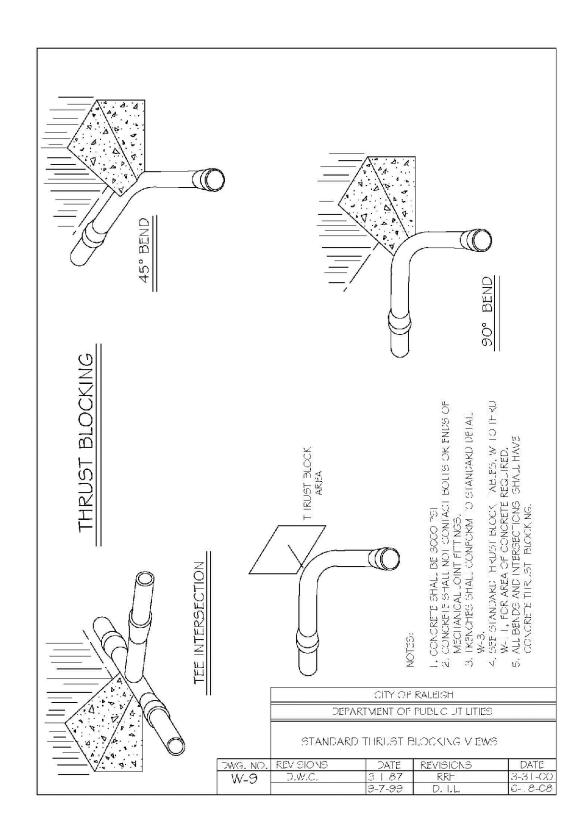


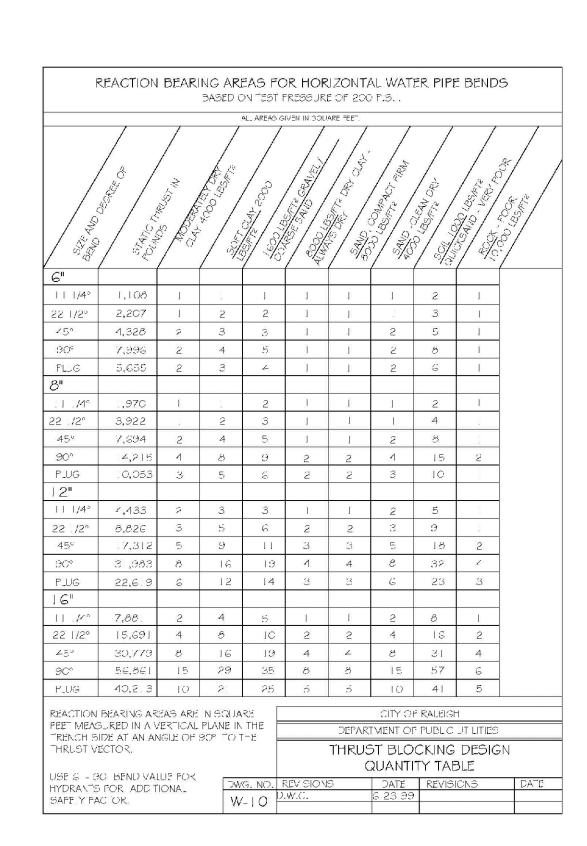


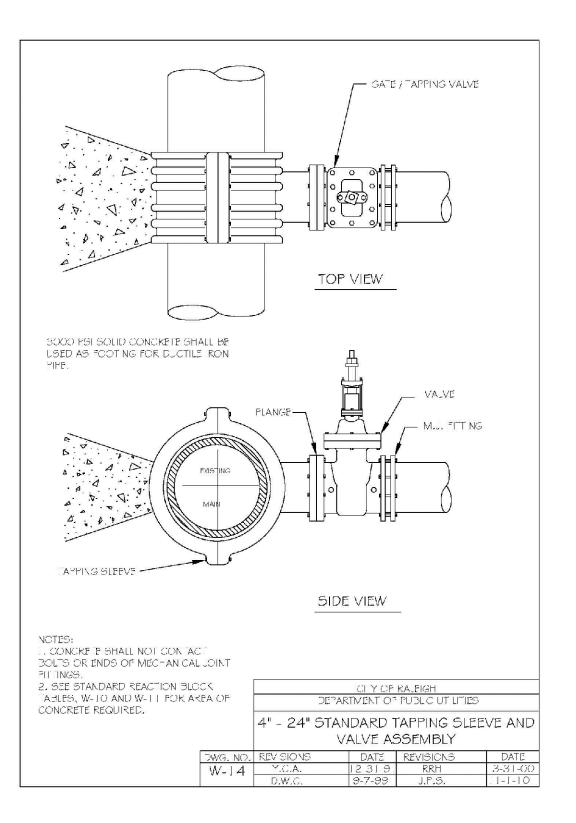


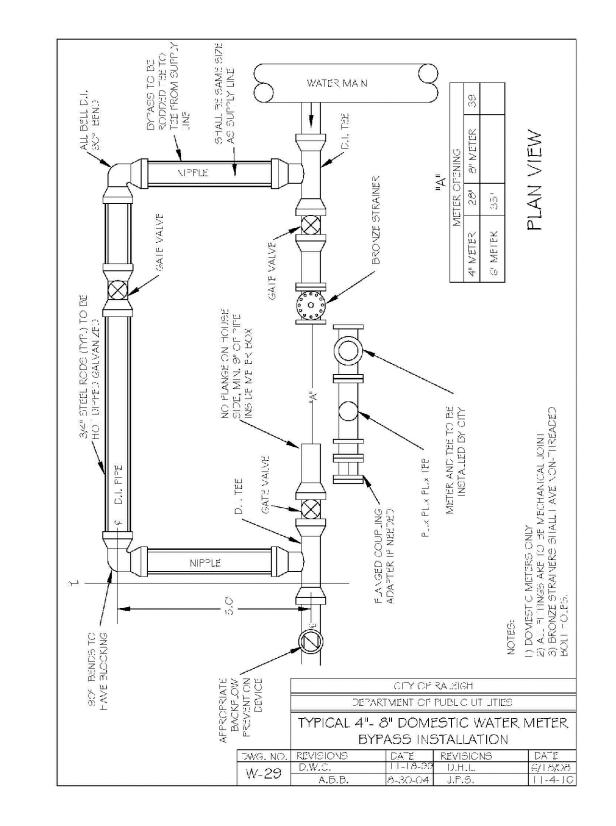

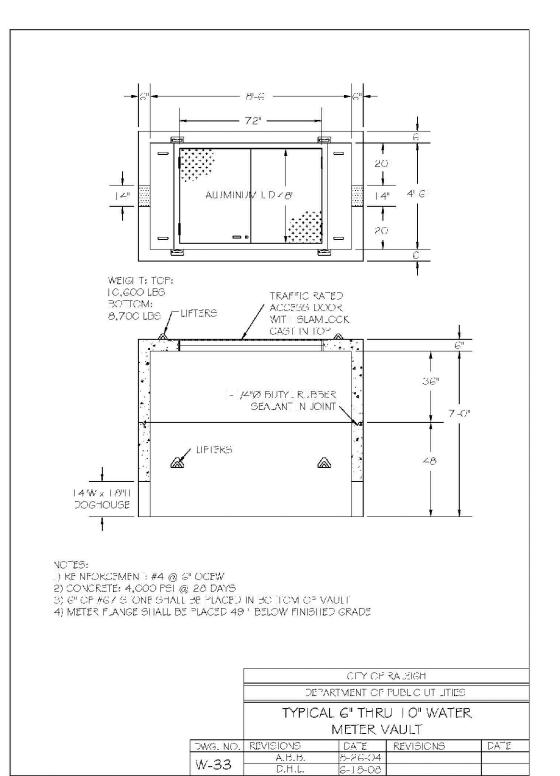

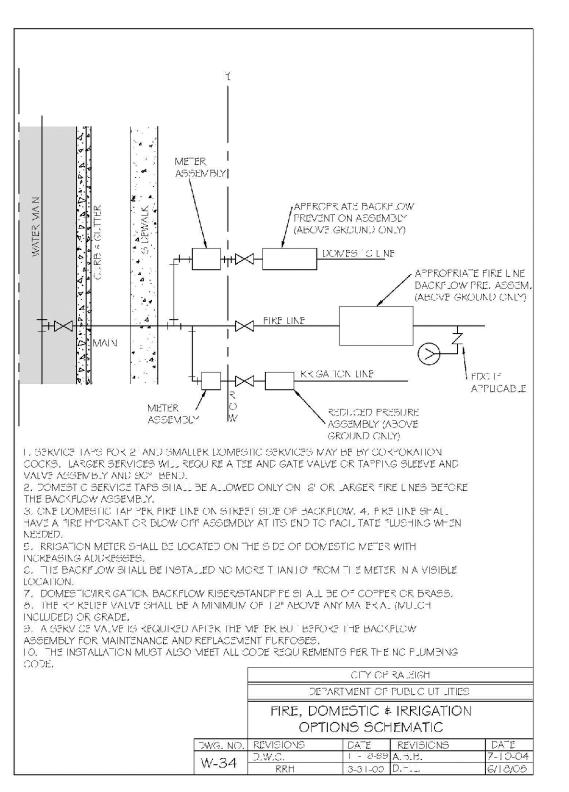


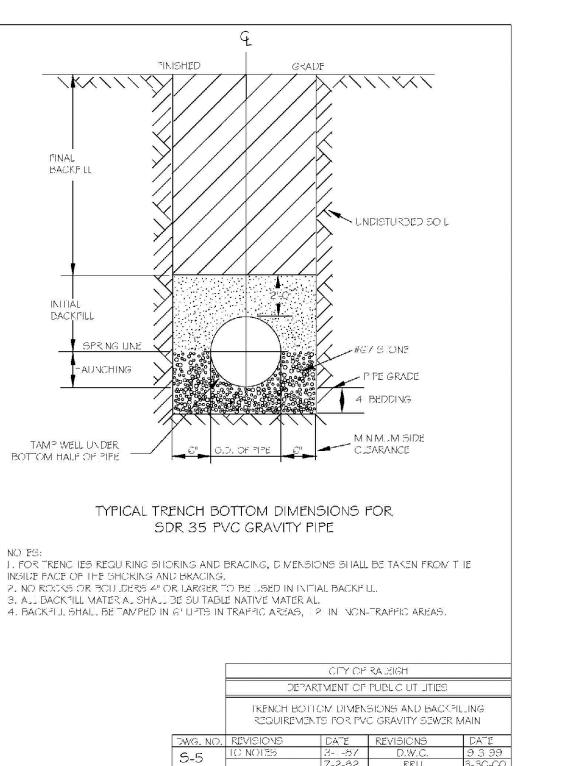

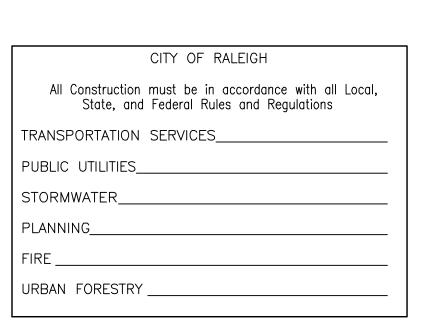

all Local,	NORTH HILLS E PARK AT NOR	& DARTIN RALEIGH, I	OTS ON STATE
	PROJECT NO.	DLR-140	00
	FILENAME:DLR1	4000-D	1
	DESIGNED BY:	ARP	
	DRAWN BY:	NDW	
	SCALE:	NTS	
	DATE: 07	' - 01-20	15

E CONCORD HOTEL
EAST TWO, LLC
COMMON OAKS DRIVE
LEIGH, NC 27614

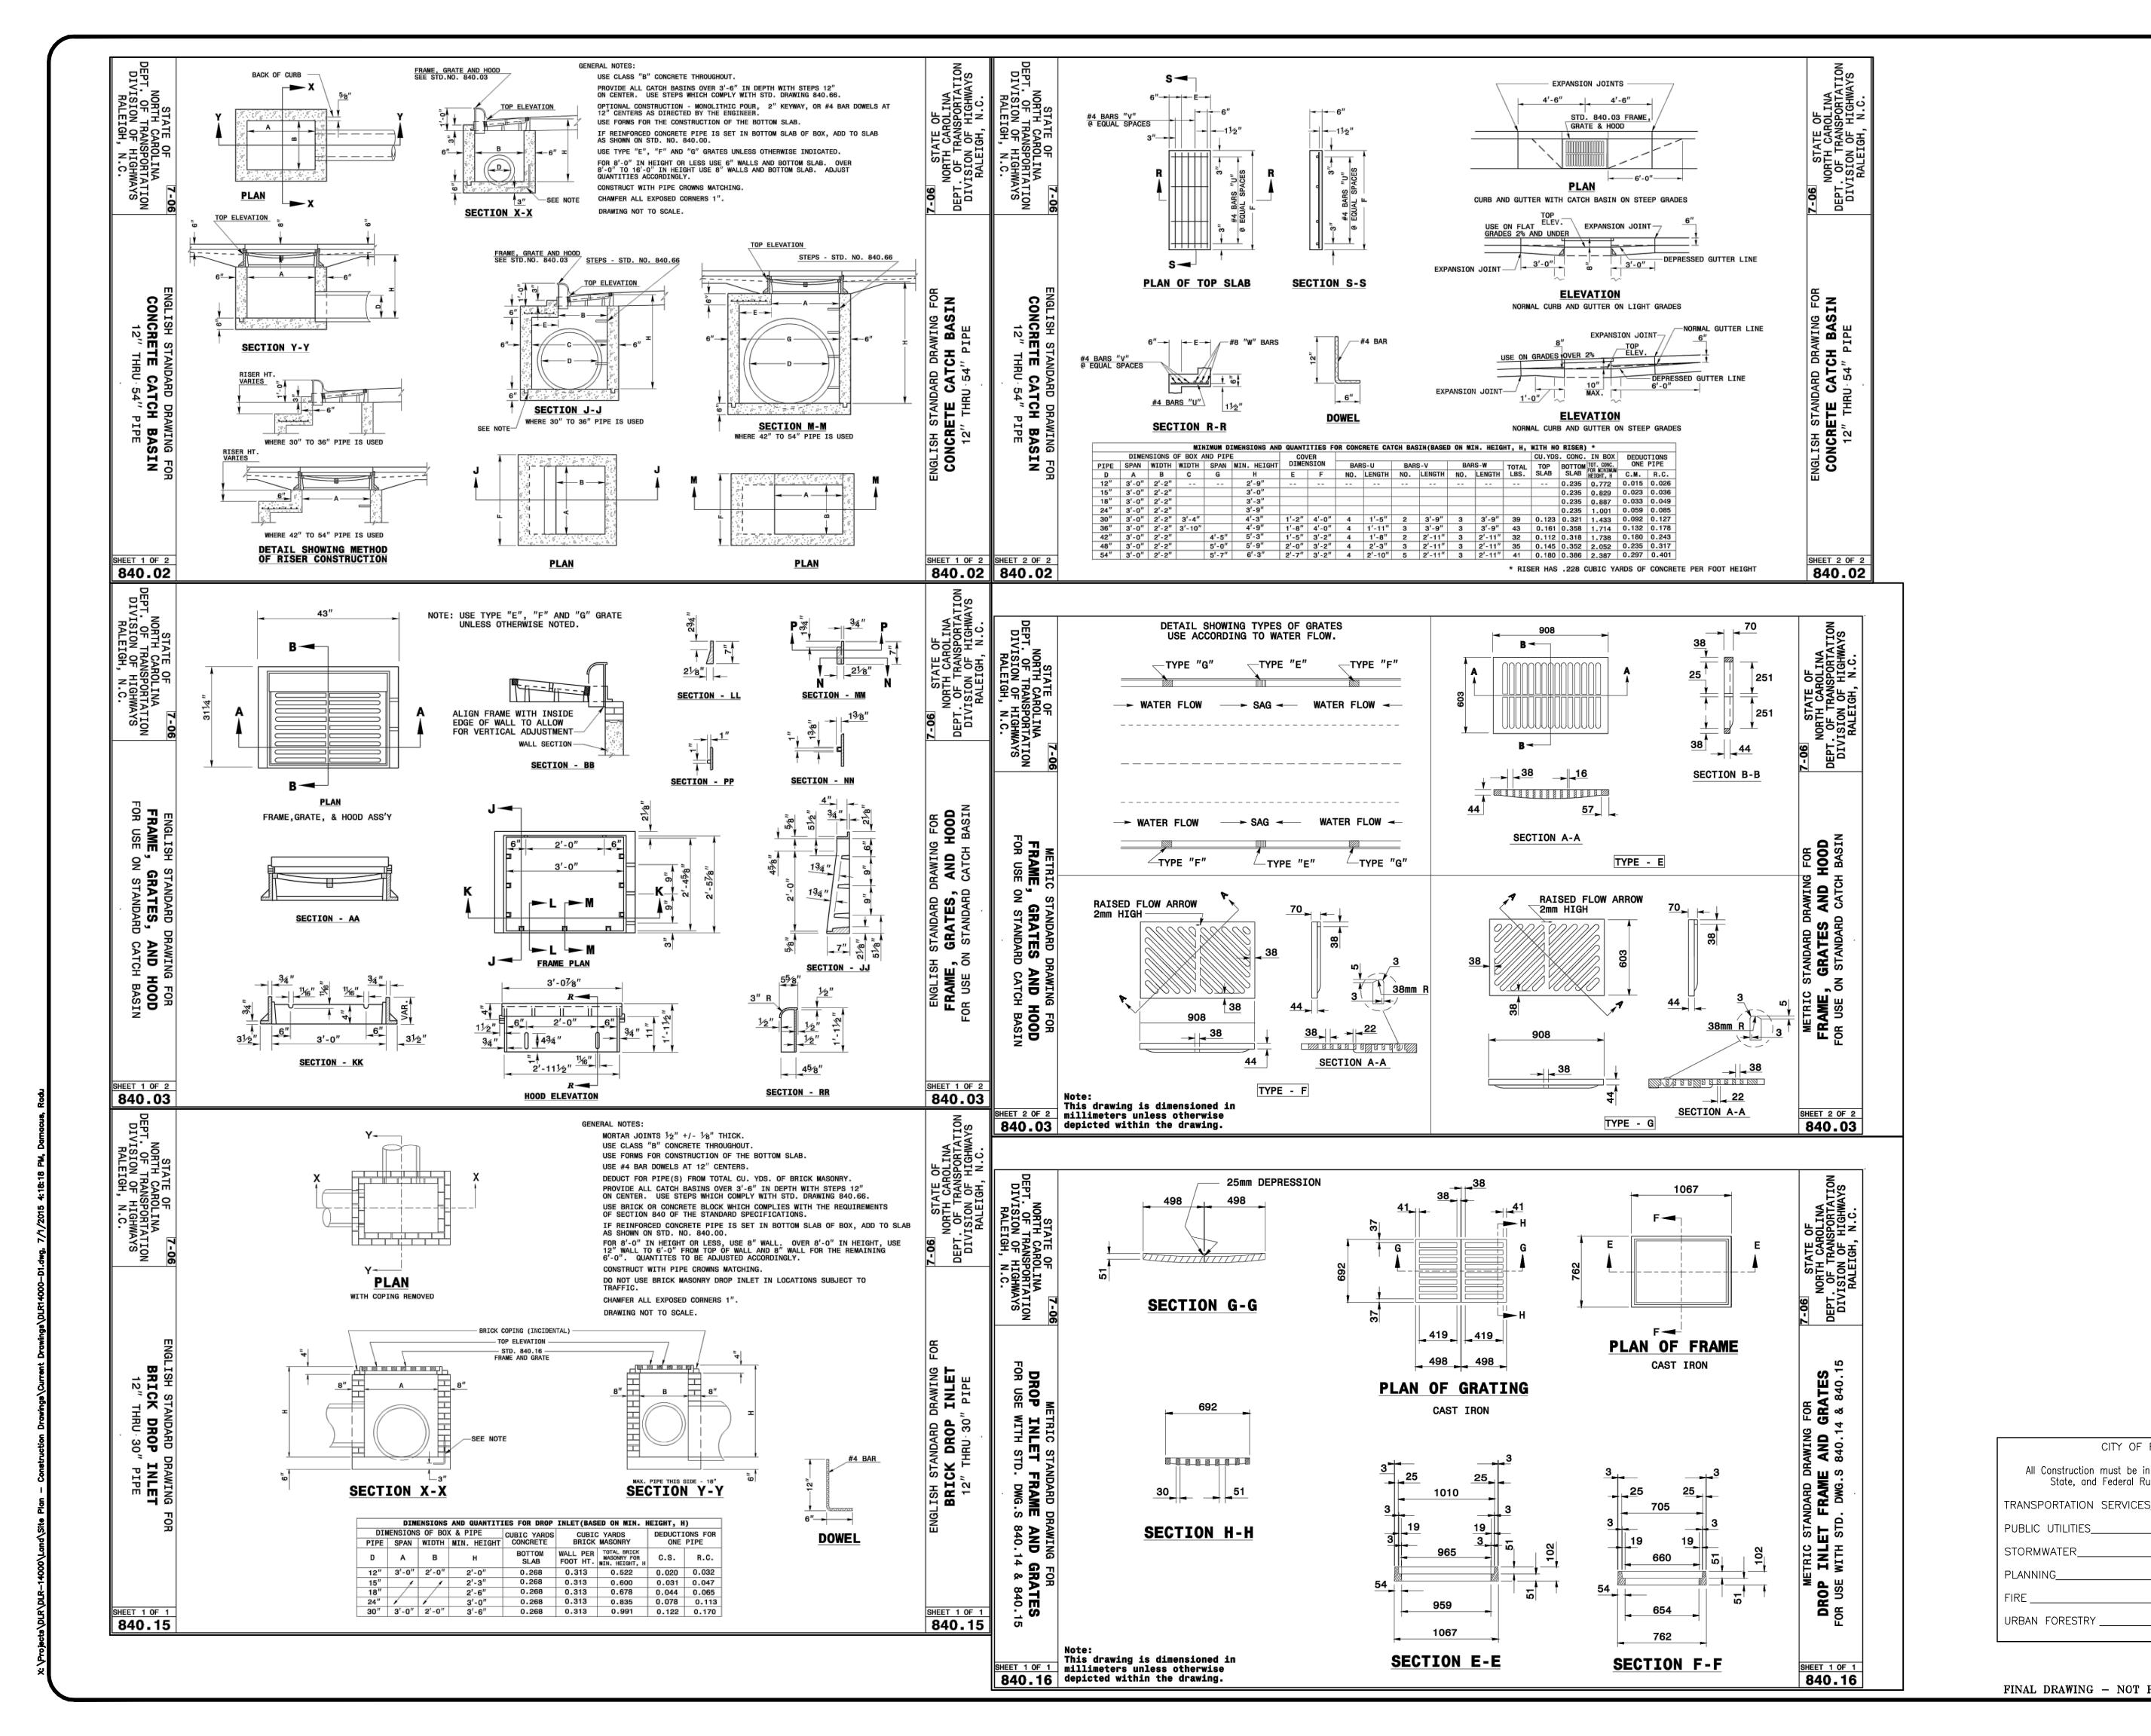

MARRIOTT HILL KAT & D NORTH FILENAME:DLR14000-D1 DESIGNED BY: ARP

S DRIVE

410 RA

NDW

PROJECT NO. DLR-14000 NTS 07-01-2015 D-3

当McAdams

FINAL DRAWING - NOT RELEASED FOR CONSTRUCTION

CITY OF RALEIGH

All Construction must be in accordance with all Local, State, and Federal Rules and Regulations

E11. not used.

WALL MATERIAL

E15) FB-1

LEVEL 08 - ROOF 182' - 8"

BRICK RETURN
BEYOND
LEVEL 01
100' - 0"

E8

55 **ELEVATION - EAST**A5.1 SCALE: 1/8" = 1'-0"

+++-+-+-+

^______

A7.7

FCS-1

GRADE - MECH ROOM 96' - 0"

51 ELEVATION - SOUTH
A5.1 SCALE: 1/8" = 1'-0"



LEVEL 02 116' - 0"

__GRADE - MECH ROOM 96' - 0"

EXTERIOR ELEVATION KEYNOTES

E1. FINISHED GRADE, SEE CIVIL DRAWINGS.
E2. COMPOSITE METAL COLUMN COVERS
E3. CONCRETE MASONRY - PAINT HPC WHERE

E4. STEPPED MASONRY VENEER TRANSITION FROM FB TO CMU E5. PREFINISHED METAL "BROW" E6. PREFINISHED METAL COPING


E7. ALUMINUM COLUMN COVER E8. ALUMINUM STOREFRONT SYSTEM
E9. ALUMINUM COVER @ FLOORLINE
E10. ALUMINUM SLIDING DOOR SYSTEM E11. not used.


E12. INSULATED HOLLOW METAL DOOR AND FRAME. E13. LOUVER - CUSTOM COLOR TO MATCH ADJACENT WALL MATERIAL


E14. GLASS GUARDRAIL SYSTEM E15. CONTROL JOINT E16. DECORATIVE REVEAL E17. PANEL JOINT E18. TRASH ENCLOSURE LOCKABLE GATES AND MANDOOR. HSS POSTS WITH COMPOSITE WOOD HORIZ

SLAT @ 1/2" SPACING. E19. MECHANICAL ENCLOSURE E20. WALL HYDRANT E21. GAS METER E22. PIPE BOLLARD E23. BUILDING SIGNAGE E24. FIRE DEPARTMENT CONNECTION E25. PREFAB METAL STAIR/RAILING SYSTEM.

EIFS = EXTERIOR INSULATED FINISH SYSTEM FB = FACE BRICK FCS = FIBER CEMENT WALL PANEL SYSTEM

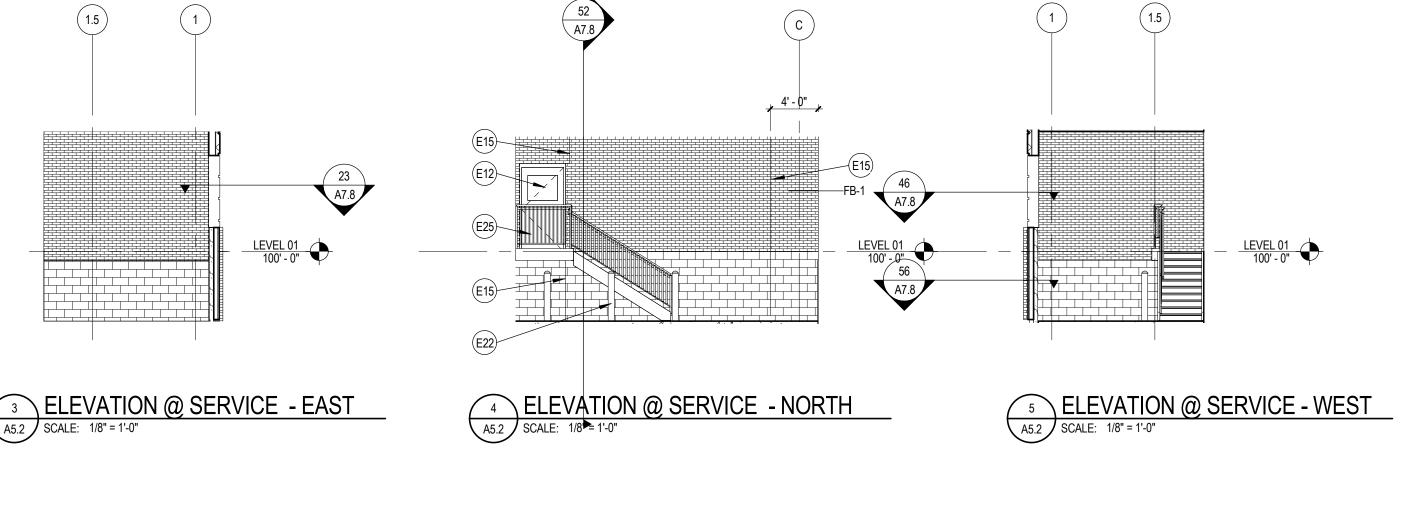


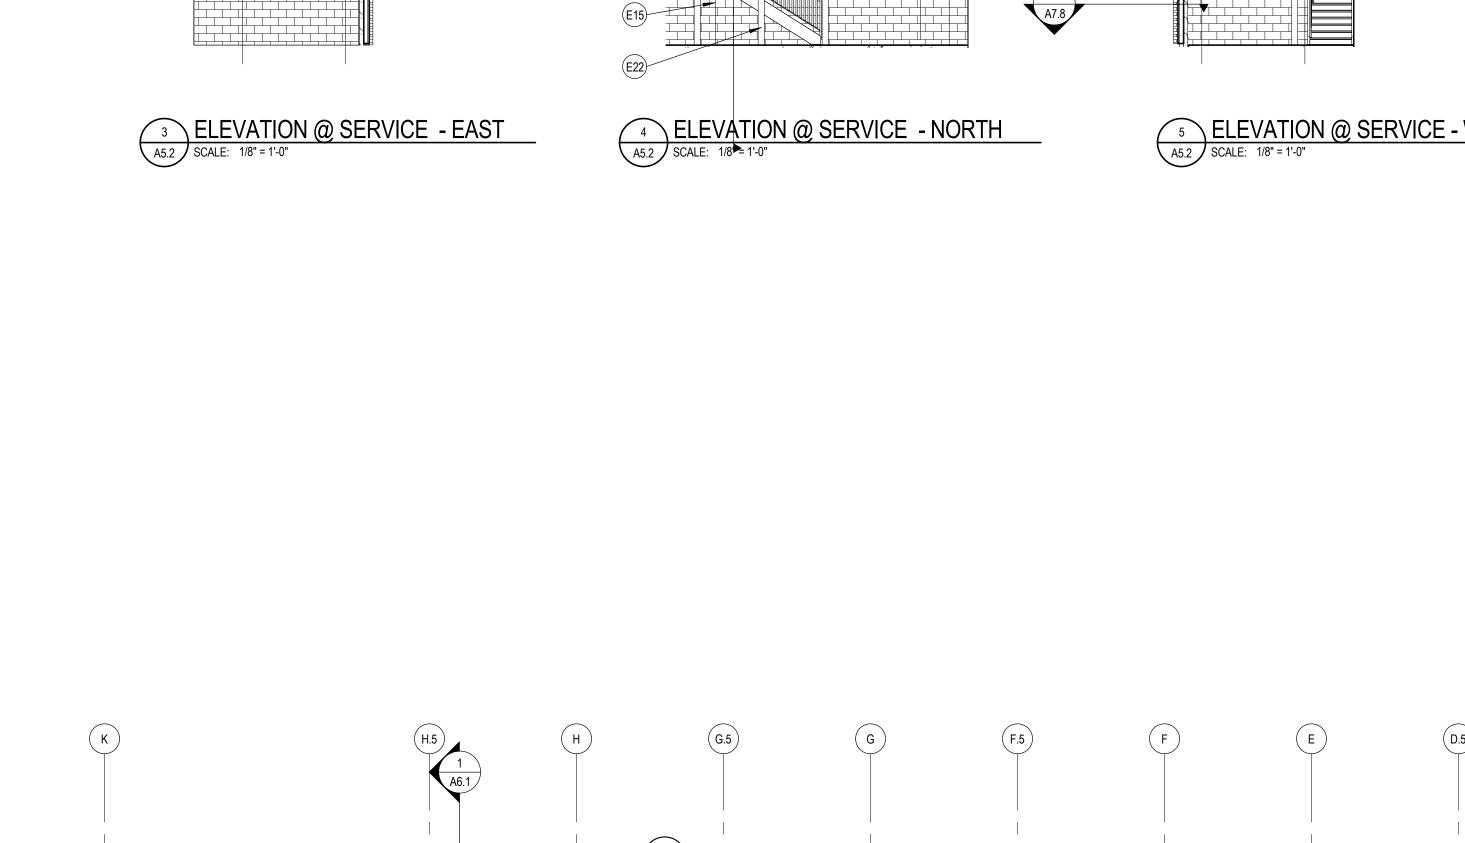

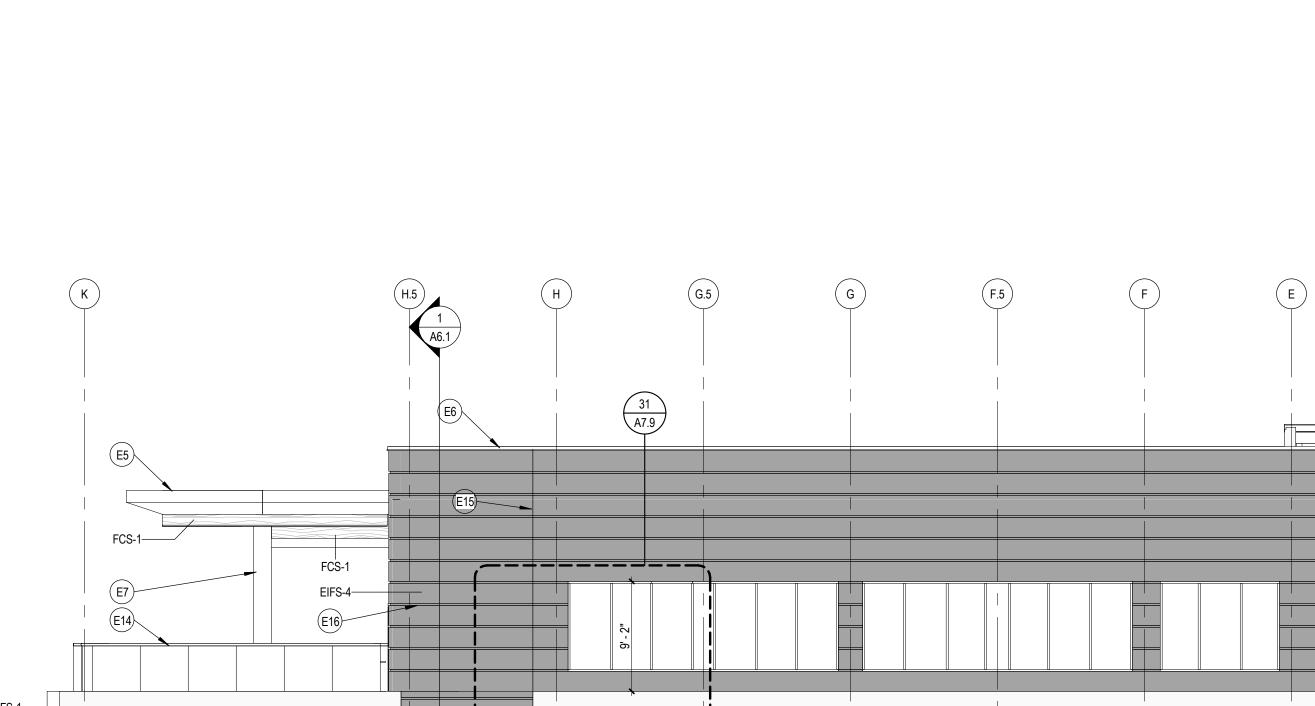

20' - 8 1/8"

51 **ELEVATION - NORTH**A5.2 SCALE: 1/8" = 1'-0"

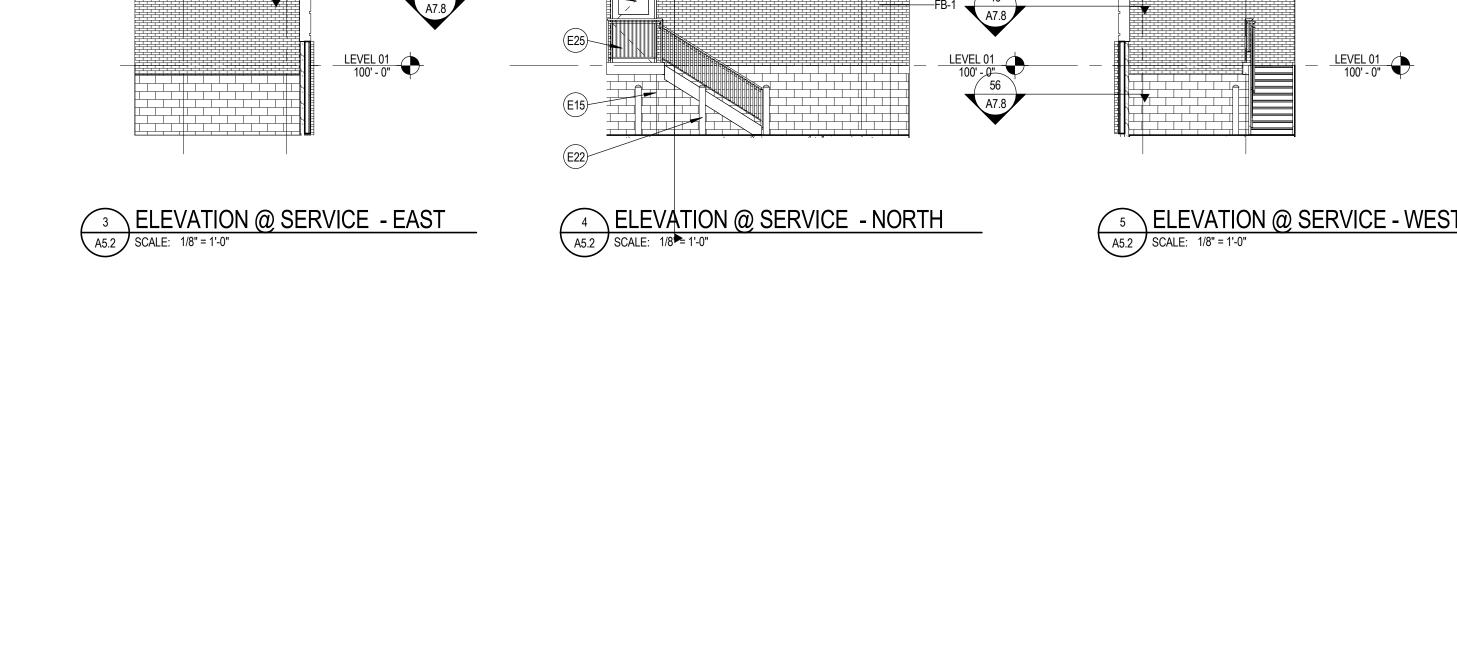

OPEN TO SERVICE
BAY BEYOND

E15 E15 E15

55 **ELEVATION - WEST**A5.2 SCALE: 1/8" = 1'-0"

